# HADLEY PARK STAGE 1

14-278 Old Castlereagh Road, Castlereagh, NSW 2749

ARCHITECTURAL DRAWING LIST

WD001 Cover Page

WD100 Site Plan - Existing

WD200 Main House Plans - Existing WD201 Main House Elevations - Existing

WD202 Main House Roof Plan and Laundry Elevations - Existing

WD300 Weatherboard Cottage Plan - Existing WD301 Weatherboard Cottage Elevations - Existing WD302 Reference Images - Gate, Chimneys, Render

WD400 Stables and Garage Plan - Existing WD401 Stables and Garage Elevations - Existing

WD500 Creamery Plan - Existing WD501 Creamery Elevations - Existing

WD600 Dairy and Milk Storage Shed Plan - Existing WD601 Dairy and Milk Storage Shed Elevations - Existing WD602 Race and Fencing Plan - Existing

WD700 Feed Store and Cow Bails Plan - Existing WD701 Feed Store and Cow Bails Elevations - Existing WD702 Feed Store and Cow Bails Roof Plan - Existing

WD800 Guest House Plan - Existing WD801 Guest House Elevations - Existing

WD900 Hay Shed Plan - Existing Ground and Roof WD901 Hay Shed Elevations - Existing

THESE DRAWINGS ARE TO BE READ IN CONJUNCTION WITH THE STRUCTURAL AND CIVIL DOCUMENTATION.

# STRUCTURAL DRAWING LIST

1842- S101 House Notes

1842- S102 House Ground Floor

1842- S103 House First Floor and Lower Ceiling Plans

1842- S104 House Upper Ceiling and Lower Roof Plans

1842- S105 House Elevations

1842- S106 House Sections and Details

1842- S107 Weatherboard Cottage Roof Framing Remedial Work Plan and Details

1842- S108 Timber Remedial Works Sections and Details Sheet 1

1842- S109 Timber Remedial Works Sections and Details Sheet 2

CONSULTANT CONTACT DETAILS

Consultant Structural - Ducros Design Contact Person: Mark Du Cros

26 Telegraph Road, Pymble, NSW 2073 Address:

9488 7374 Telephone 0409 409 034 Mobile:

GENERAL NOTES

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Email: mark@ducrosdesign.com.au

# GENERAL NOTES

EXISTING MATERIALS WHICH HAVE PREVIOUSLY BEEN REMOVED FROM THE BUILDINGS ARE STOCKPILED IN THE FEED STORAGE SHED.

NO EXISTING FABRIC IS TO BE REMOVED FROM SITE OR DISPOSED OF WITHOUT WRITTEN APPROVAL OF THE ARCHITECT.

SALVAGE LOOSE MATERIAL WHEREVER POSSIBLE FOR POTENTIAL REINSTATEMENT OR FUTURE USE.

SALVAGED MATERIAL NOT INCORPORATED IN THE WORK IS TO BE STORED WITHIN STORAGE SHFD 2

REVIEW THE CONDITION OF ALL SALVAGED ITEMS. DETERMINE IF IT IS POSSIBLE TO REINSTATE THEM IN THEIR ORIGINAL LOCATION.

THE RETENTION OF EXISTING MATERIAL IS TO BE MAXIMISED. IF EXISTING MATERIAL IS NOT ABLE TO BE REPAIRED OR REINSTATED. REPLACE WITH NEW TO MATCH EXISTING.

ALL MATERIALS AND SPECIFICATIONS ARE TO MATCH THE EXISTING WITH LIKE FOR LIKE REPLACEMENTS BEING APPROVED BY THE ARCHITECT PRIOR TO THE INCORPORATION.

ALL NEW MATERIALS ARE TO BE INDELIBLY AND DISCRETELY MARKED WITH THE YEAR OF INSTALLATION IN ORDER TO DISTINGUISH THEM FROM THE EXISTING FABRIC.

HEAVY MACHINERY IS NOT TO BE USED WITHIN 2 METRES OF THE EXTERIOR OF BUILDINGS AND STRUCTURES.

ALL WORKS ARE TO BE UNDERTAKEN BY SUITABLY QUALIFIED AND EXPERIENCED TRADESPEOPLE.

VEGETATION ENCROACHING WITHIN THE BUILDINGS, INCLUDING ROOFS AND FLOORS, IS TO BE REMOVED

BEFORE PRUNING OR LOPPING ANY TREES OR SIGNIFICANT VEGETATION, OBTAIN ADVICE FROM A HERITAGE LANDSCAPE CONSULTANT AND ARBORIST.

EXISTING UNPAINTED ITEMS ARE TO REMAIN UNPAINTED

13/07/22 ISSUE FOR REVIEW 01/08/22 FINAL DRAFT FOR REVIEW

13/10/22 SECTION 60 APPLICATION

24/08/22 CONSULTANT COORDINATION

08/12/22 CONSULTANT INFORMATION

# ARCHAEOLOGY NOTES

AN ARCHAEOLOGIST APPOINTED BY THE PRINCIPAL IS TO SUPERVISE ALL EXCAVATION WORKS, AND WORKS TO FLOORS AND OTHER AREAS WHERE FINDS ARE LIKELY.

MANY MOVEABLE ITEMS HAVE BEEN FOUND IN THE SOIL AROUND BUILDINGS AND DIRT FLOORS WITHIN THE BUILDINGS. IT IS LIKELY THAT MANY REMAIN. WHERE DIRT FLOORS AND SOIL ARE NOTED TO BE REGRADED. WORKS ARE TO BE CARRIED OUT WITH SUPERVISION OF AN ARCHAEOLOGIST. ANY OBJECTS EXPOSED ARE TO HAVE THEIR LOCATIONS AND DETAILS RECORDED AND RETAINED FOR INCLUSION IN THE MOVEABLE COLLECTION STORED OFF-SITE.

# METALWORK NOTES

ALL IRONMONGERY IS TO BE RETAINED IN PLACE.

CHECK ALL ROOF SHEETS AND RE-SECURE AS NECESSARY, FIXINGS TO MATCH EXISTING.

SALVAGE FALLEN SHEETS AND REVIEW CONDITION FOR REINSTATEMENT.

ANY NEW SHEETS OF ROOF AND WALL CLADDING ARE TO BE SUPPLIED IN SHORT SHEET LENGTHS AND MATCH THE EXISTING PROFILE AND FINISH

TREAT RUST WITH 'PENETROL' OR SIMILAR.

# BRICKWORK NOTES

200MM

LOOSE BRICKS ARE TO BE SALVAGED AND REVIEWED FOR RE-USE IN THE WORKS. BRICKS SUITABLE FOR RE-USE ARE TO BE DESALINATED PRIOR TO USE.

REPLACEMENT OF FRETTED BRICKWORK IS TO BE UNDERTAKEN IN ACCORDANCE WITH STRUCTURAL ENGINEER'S ADVICE AND IN CONSULTATION WITH THE ARCHITECT.

WHERE REPOINTING OR REPLACEMENT OF MORTAR IS REQUIRED, NEW MORTAR IS TO MATCH EXISTING. SAMPLES TO BE PROVIDED TO ARCHITECT FOR APPROVAL PRIOR TO WORKS. REPAIRS TO CRACKING AND POINTING ARE TO BE IN ACCORDANCE WITH STRUCTURAL ENGINEER'S ADVICE.

# ARCHIVAL RECORDING

PRIOR TO ANY DISASSEMBLY OR DEMOLITION WORKS. THE EXISTING ASSEMBLY IS TO BE DOCUMENTED IN ACCORDANCE WITH THE NSW HERITAGE OFFICE GUIDELINES FOR ARCHIVAL RECORDING.

# TIMBER NOTES

INSPECT ALL TIMBER MEMBERS FOR DECAY AND DAMAGE. DRILL TEST AREAS IDENTIFIED IN ACCORDANCE WITH STRUCTURAL ENGINEER'S ADVICE.

SPLICE EXTEND MEMBERS WHERE DAMAGE IS PARTIAL IN ACCORDANCE WITH DOCUMENTED

WHERE TIMBER MEMBERS ARE IN CONTACT WITH THE GROUND. INJECT WITH PENETRATING PRESERVATIVE. APPROVED BY ARCHITECT PRIOR TO USE.

RE-FIX ANY LOOSE ITEMS. FIXINGS TO MATCH EXISTING.

SALVAGE FALLEN WALL SLABS, TIMBER AND METAL CLADDING. REVIEW CONDITION FOR REINSTATEMENT

EXPOSED ENDS OF TIMBER MEMBERS ARE TO BE TREATED WITH PENETRATING PRESERVATIVE. APPROVED BY ARCHITECT PRIOR TO USE.

INSTALL NEW POSTS USING DURABILITY CLASS 2 HARDWOOD.

# CONCRETE NOTES

RE-PACK UNDER EXISTING CONCRETE SLABS WHERE SUB-GRADE HAS WASHED OUT.

# STORMWATER DRAINAGE NOTES

THE EXISTING STORMWATER DRAINAGE LINES ARE TO BE CHECKED TO ENSURE THEY DRAIN FREELY. EXISTING DOWNPIPES TO THE HOUSE ARE TO BE CONNECTED BELOW GROUND TO THE EXISTING SYSTEM. REFER TO CIVIL/SERVICES ENGINEERING DOCUMENTATION.

# HYDRAULIC SERVICES

CAP OFF HYDRAULIC SERVICES IN THE EXISTING LAUNDRY BUILDING TO FACILITATE THE BUILDING'S DEMOLITION.

# PEST MANAGEMENT NOTES

EXISTING PEST CONTROL MEASURES IN PLACE ARE TO BE MAINTAINED UNDISTURBED DURING THE WORKS. IF DISTURBANCE IS UNAVOIDABLE, ALLOW EQUIVALENT TEMPORARY MEASURES FOR THE DURATION OF THE PROJECT.

WHERE EXPOSING THE BASE OF MEMBERS SET INTO THE GROUND. CLEAR OUT ANY TERMITE NESTS OR SIMILAR AND AFFECTED SOIL, IF FOUND.



Department of Planning and Environment

Issued under the Environmental Planning and Assessment Act 1979 Approved Application No: DA 23/907

pproved on: 23 June 2023

Signed: AW Sheet No: 1 of 35

ARCHITECTURE INTERIORS HERITAGE

SUITE C2.09 22-36 MOUNTAIN STREET ULTIMO NSW 200 TEL: (02) 9211 221 WWW.JPAD.COM.AI

HADLEY PARK STAGE 1

CASTLEREAGH, NSW 2749

AND ENVIRONMENT

PROJECT TITLE

PROJECT ADDRESS 14-278 OLD CASTLEREAGH ROAD,


DEPARTMENT OF PLANNING, INDUSTRY COVER SHEET AND NOTES

SCALE SHEET SIZE N.T.S. А3 JΡ MS JР JOB No. DRAWING No 2110 WD001 F

USE FIGURED DIMENSIONS IN PREFERENCE TO SCALING. 100 CHECK ALL DIMENSIONS ON SITE

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content and statement. The elements shown on this drawing are prototypical design only. They may not be utilised, altered, the specification changed, or implemented in part, or in whole, in any structure without notification and written approval being issued by JPA&D Australia

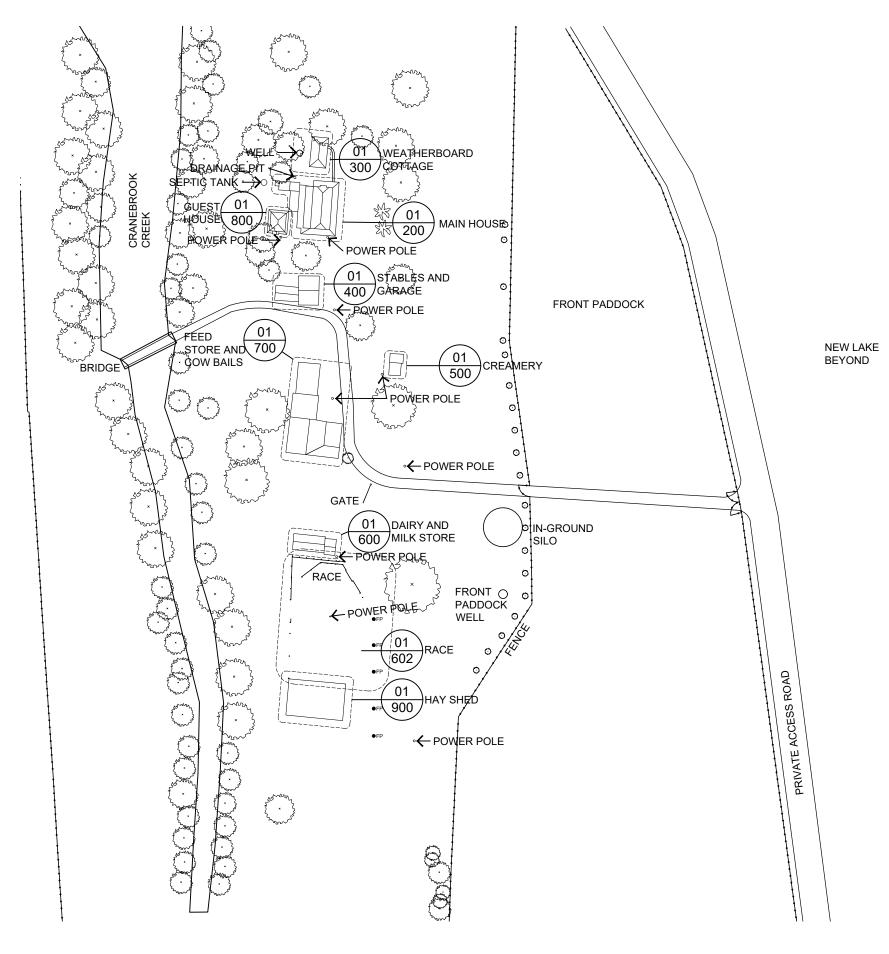

# NOTES:

# FRONT PADDOCK WELL:

NUMBER AND RECORD THE LOCATION OF THE BRICKS IN THE TOP 6 COURSES OF THE WELL.

WHEN FIRST 6 COURSES HAVE BEEN DISMANTLED, INVESTIGATE THE METAL STRAPPING AND TREAT WITH 'PENETROL' OR SIMILAR AND RESET.

POISON TREE ROOT AND REMOVE. DRY LAY THE BRICKS IN THE SAME LOCATIONS AS PREVIOUSLY. FOR THE LAST 3 COURSES FILL PERPENDS WITH SUITABLE SOFT LIME MORTAR AND FLAUNCH AT THE BACK

REGRADE THE GROUND SURFACE AROUND THE WELL TO PREVENT OVERLAND FLOW ENTERING THE WELL. SPRAY FIRST 1.2 m (OR AS FAR AS PRACTICAL REACH ALLOWS) WITH LIME WATER TO REDUCE SURFACE FRETTING. ALLOW FOR ARCHAEOLOGICAL SUPERVISION TO ALL WORKS TO THE WELL.

### **FENCES AND GATES:**

PROVIDE NEW HARDWOOD TIMBER POSTS TO EXISTING HOLES. ALLOW FOR 5 POSTS TO EXTEND 1450 mm ABOVE FINISHED GROUND LEVEL POST TO MATCH EXISTING. FOR ALL EXISTING AND NEW POSTS SET INTO THE GROUND, POLE INFUSE WITH PENETRATIVE PRESERVATIVE. CHECK OVER EXISTING FENCES AND GATES. RE-FIX LOOSE RAILS. TREAT RUST ON HINGES AND HARDWARE WITH 'PENETROL' OR SIMILAR.

FOR ALL EXISTING AND NEW TIMBER POSTS SET INTO GROUND, POLE INFUSE WITH PENETRATING PRESERVATIVE. RECONSTRUCT FRONT GATE FROM PIECES STORED ON SITE. REPAIR TIMBERS AS NEEDED. ONCE COMPLETE, STORE SECURELY ON SITE FOR FUTURE REINSTATEMENT. REFER TO WD302 FOR IMAGES.

ESTIMATED POSITION OF EXISTING HOLE OF FORMER •FP FENCE POST. INFILL WITH NEW POST PER "FENCES AND GATES" ABOVE.

Department of Planning

Issued under the Environmental Planning and Assessment Act 1979

and Environment

Approved Application No: DA 23/907

Signed: AW Sheet No: 2 of 35

Approved on: 23 June 2023

NSW

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14/12/22 DEVELOPMENT APPLICATION

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HADLEY PARK STAGE 1 14-278 OLD CASTLEREAGH ROAD

CASTLEREAGH, NSW 2749


AND ENVIRONMENT


PROJECT TITLE


DEPARTMENT OF PLANNING, INDUSTRY SITE PLAN

A3 1:1000 MB JΡ 2110 WD100 G

USE FIGURED DIMENSIONS IN PREFERENCE TO SCALING. 100 CHECK ALL DIMENSIONS ON SITE.

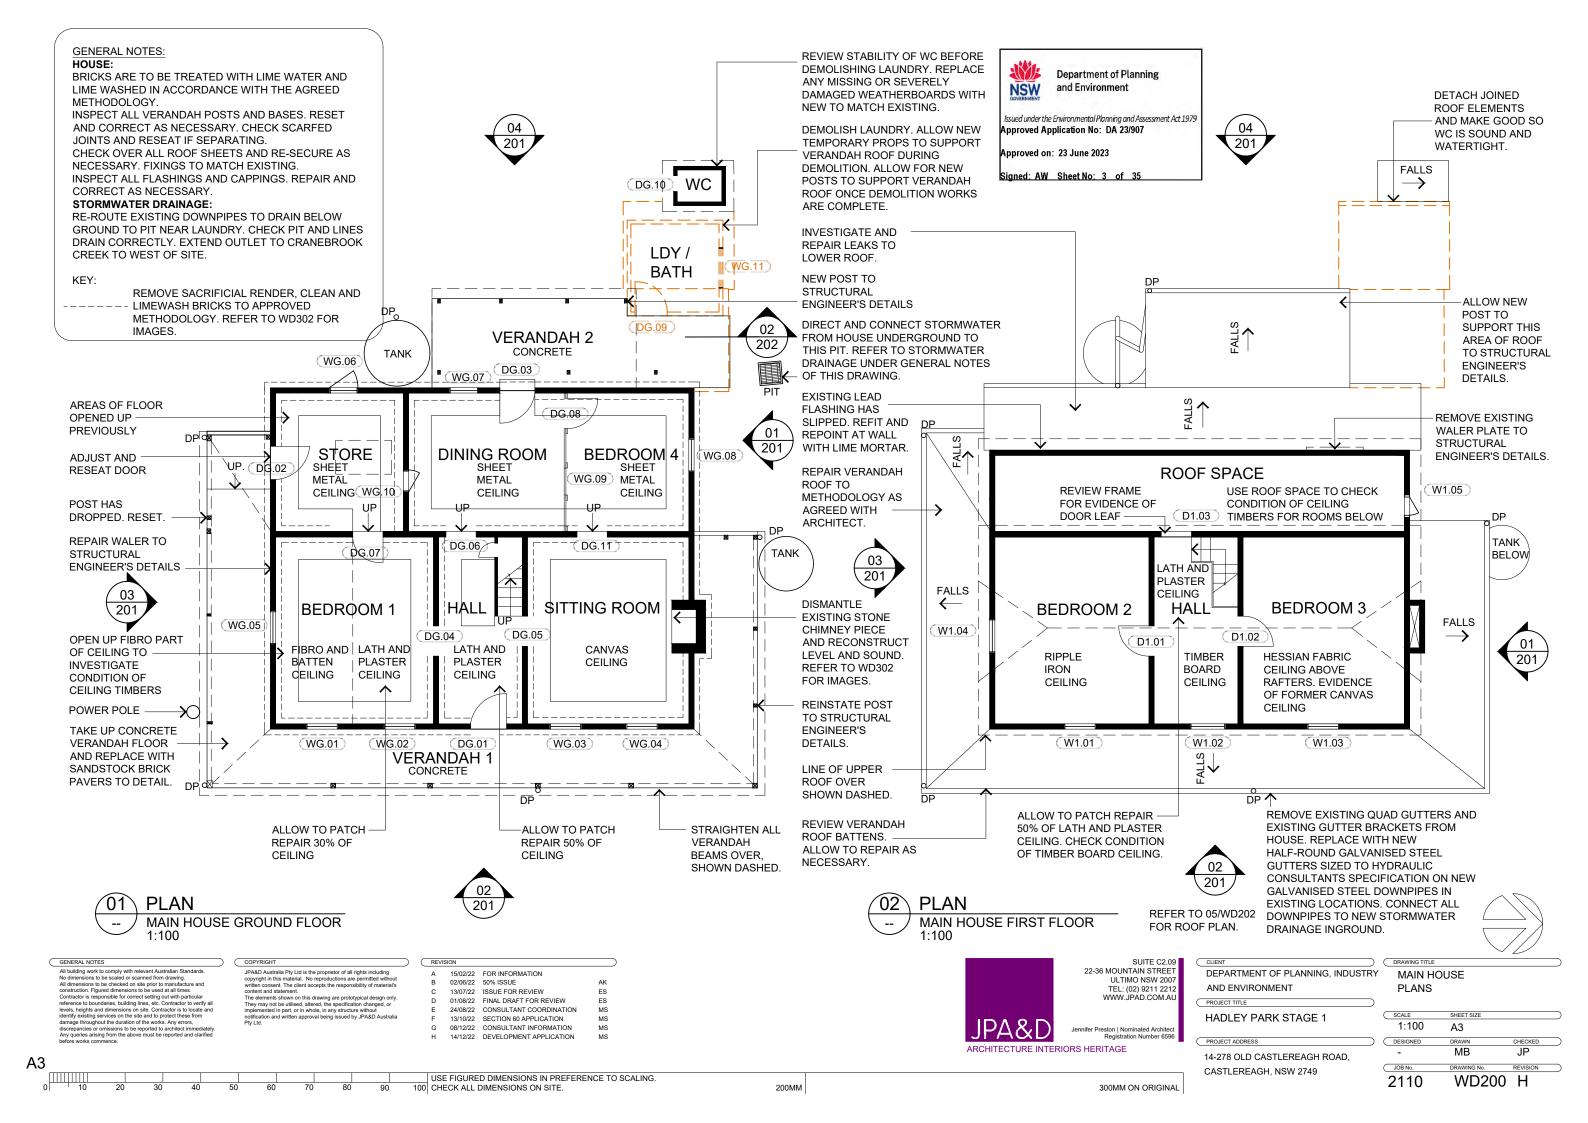

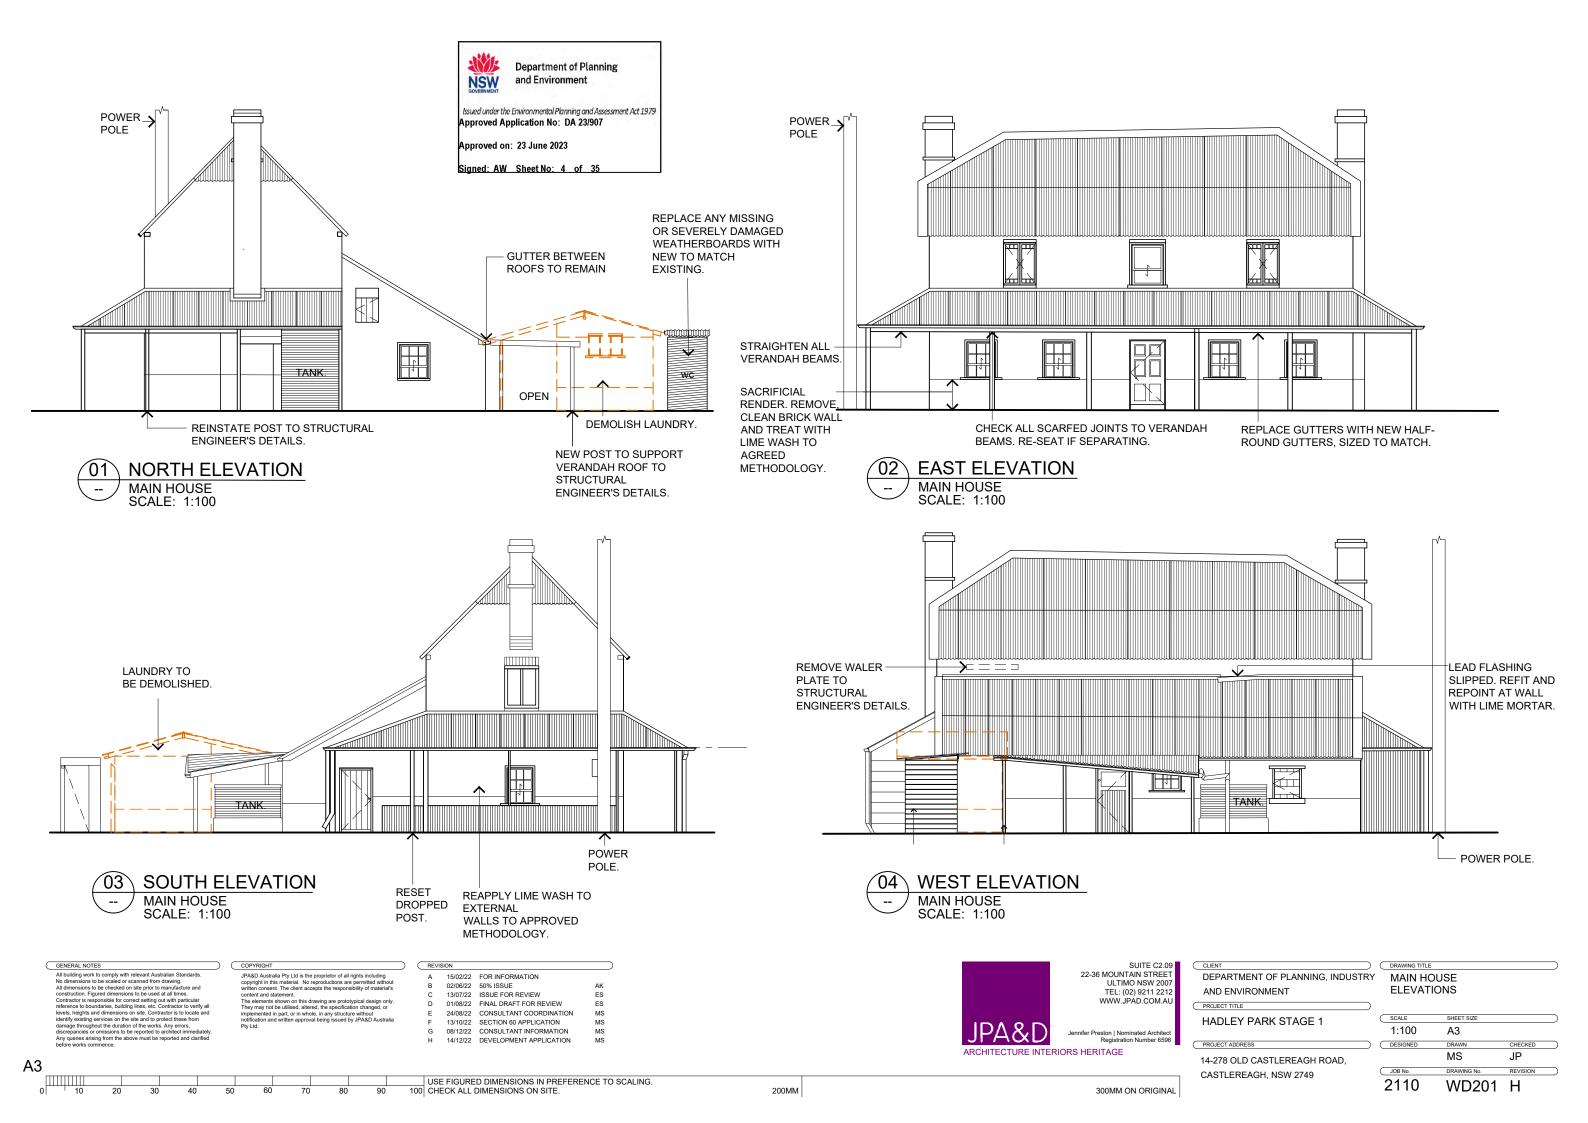

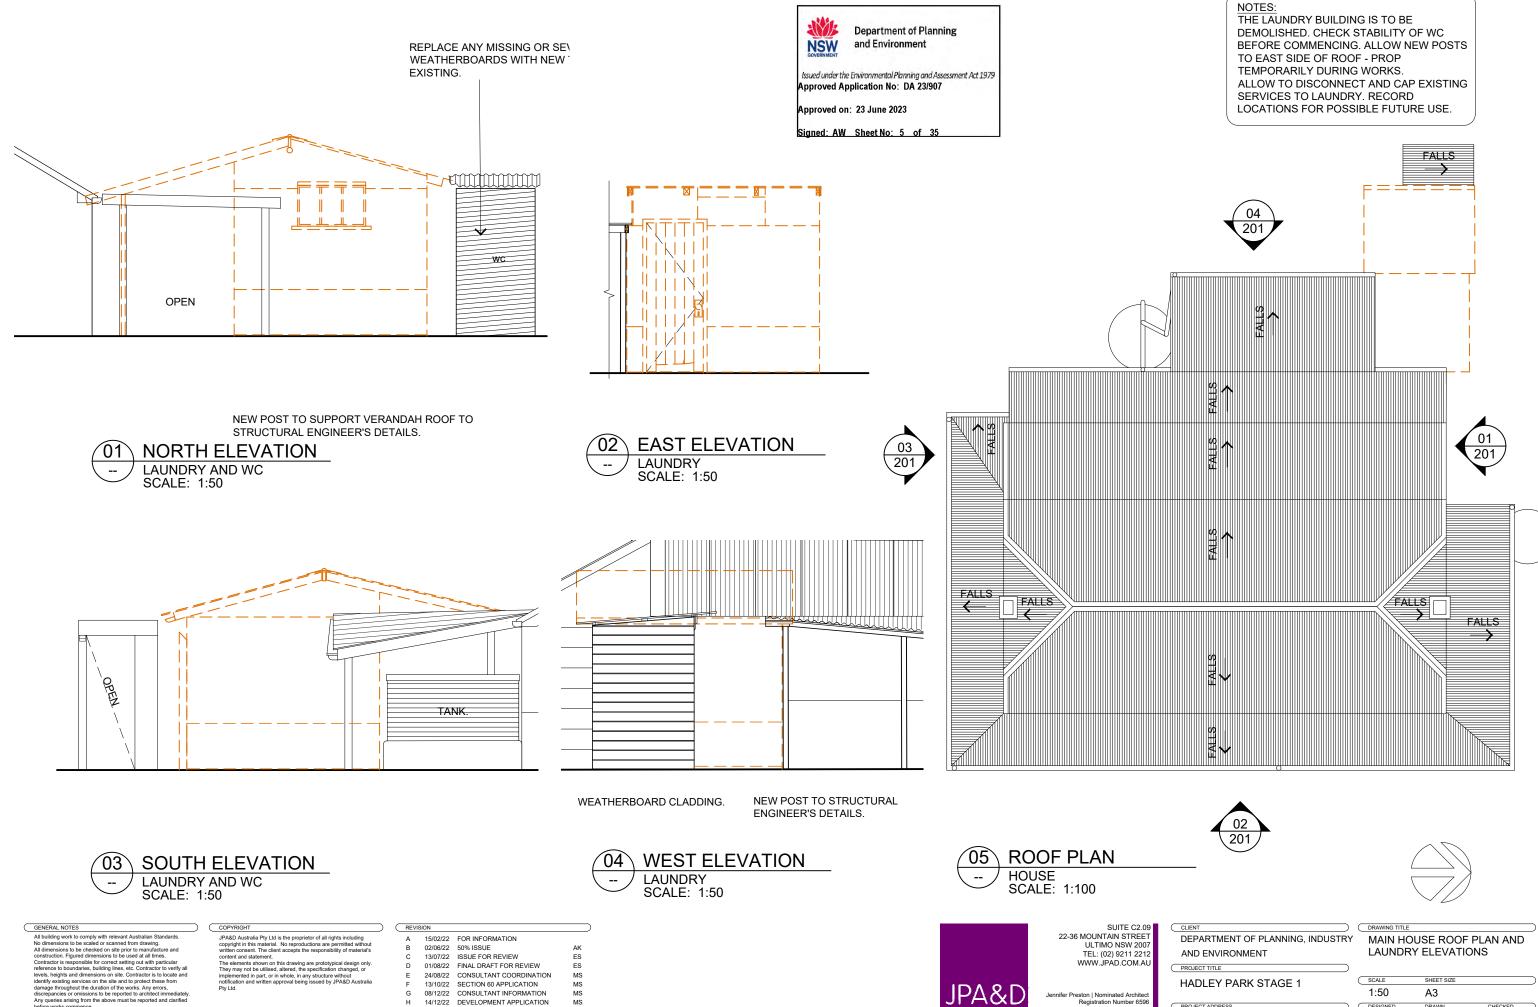

USE FIGURED DIMENSIONS IN PREFERENCE TO SCALING.
100 CHECK ALL DIMENSIONS ON SITE. 200MM

14/12/22 DEVELOPMENT APPLICATION


A3

300MM ON ORIGINAL

ARCHITECTURE INTERIORS HERITAGE

14-278 OLD CASTLEREAGH ROAD, CASTLEREAGH, NSW 2749

1:50 MS JΡ DRAWING No. REVISION 2110 WD202 H

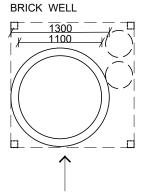

PREVIOUS WALLS, POSTS AND TANKS SHOWN DASHED. THESE WERE DEMOLISHED BY A STORM IN NOVEMBER 2021. ITEMS ARE CURRENTLY STORED IN THE FEED STORAGE SHED.



RE-GRADE GROUND LEVELS TO FALL AWAY FROM BUILDING.

WORKS TO WELL:

NUMBER AND RECORD THE LOCATION OF THE BRICKS IN THE TOP 6 COURSES OF THE WELL.


DISMANTLE TOP 6 COURSES OF BRICKWORK, INVESTIGATE THE REASON FOR LIFTING IN THE COURSE BEDDING AT THE 6TH COURSE. ADDRESS CAUSE AND RE-LAY. DRY LAY THE BRICKS IN THE SAME LOCATIONS AS PREVIOUSLY. FOR THE LAST 3 COURSES FILL PERPENDS WITH SUITABLE SOFT LIME MORTAR AND FLAUNCH AT BACK. RE-GRADE GROUND SURFACE AROUND WELL TO PREVENT OVERLAND FLOW ENTERING THE WELL.

SPRAY FIRST 1.2m (OR AS FAR AS PRACTICAL REACH ALLOWS) WITH LIME MORTAR TO REDUCE SURFACE FRETTING.

ALLOW FOR ARCHEOLOGICAL SUPERVISION TO ALL WORKS TO WELL.

**INTERNAL WORKS TO COTTAGE:** 

LIFT WIRE TIES TO ABOVE CEILING LEVEL.

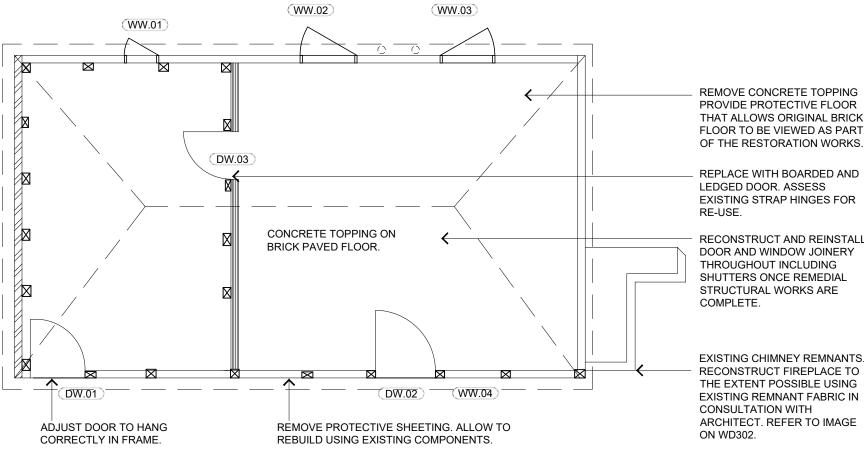


REMOVE CONCRETE TOPPING PROVIDE PROTECTIVE FLOOR THAT ALLOWS ORIGINAL BRICK FLOOR TO BE VIEWED AS PART

REPLACE WITH BOARDED AND LEDGED DOOR. ASSESS EXISTING STRAP HINGES FOR

RECONSTRUCT AND REINSTALL DOOR AND WINDOW JOINERY THROUGHOUT INCLUDING SHUTTERS ONCE REMEDIAL STRUCTURAL WORKS ARE

EXISTING CHIMNEY REMNANTS. RECONSTRUCT FIREPLACE TO THE EXTENT POSSIBLE USING EXISTING REMNANT FABRIC IN ARCHITECT. REFER TO IMAGE

200MM

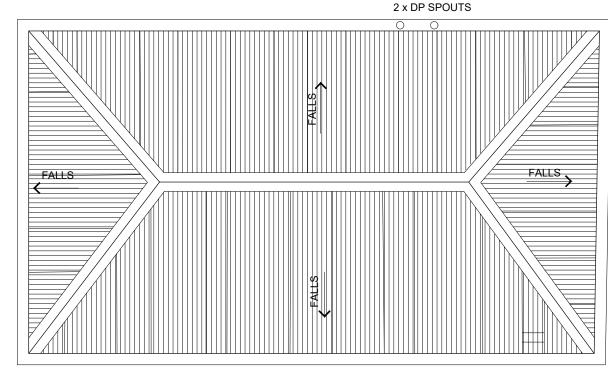



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02/06/22 50% ISSUE 13/07/22 ISSUE FOR REVIEW
24/08/22 CONSULTANT COORDINATION 13/10/22 SECTION 60 APPLICATION 08/12/22 DEVELOPMENT APPLICATION 14/12/22 DEVELOPMENT APPLICATION

**ROOF PLAN** WEATHERBOARD COTTAGE



SUITE C2.09 22-36 MOUNTAIN STREET ULTIMO NSW 200 TEL: (02) 9211 221: WWW.JPÁD.COM.A

DEPARTMENT OF PLANNING, INDUSTRY AND ENVIRONMENT PROJECT TITLE

HADLEY PARK STAGE 1 PROJECT ADDRESS


14-278 OLD CASTLEREAGH ROAD, CASTLEREAGH, NSW 2749


WEATHERBOARD COTTAGE


**PLANS** 


1:50 A3 DESIGNED JOB No. WD300 G 2110

USE FIGURED DIMENSIONS IN PREFERENCE TO SCALING. 100 CHECK ALL DIMENSIONS ON SITE.

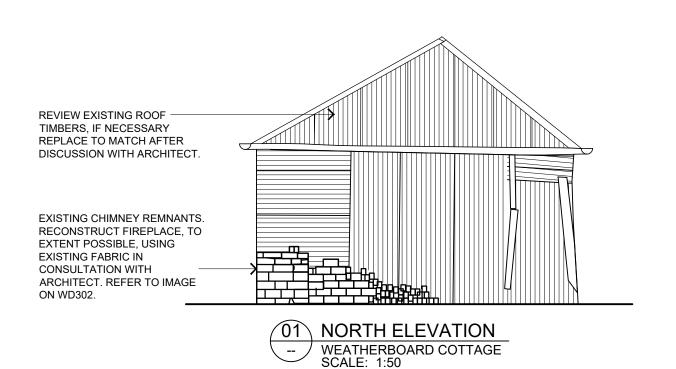

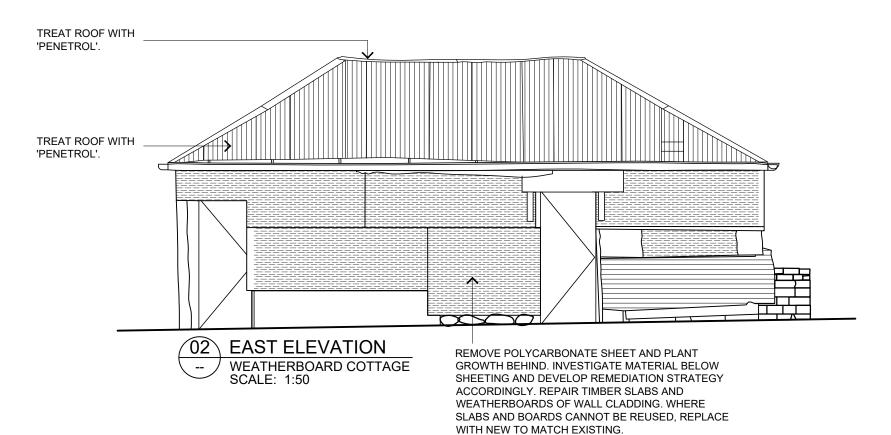

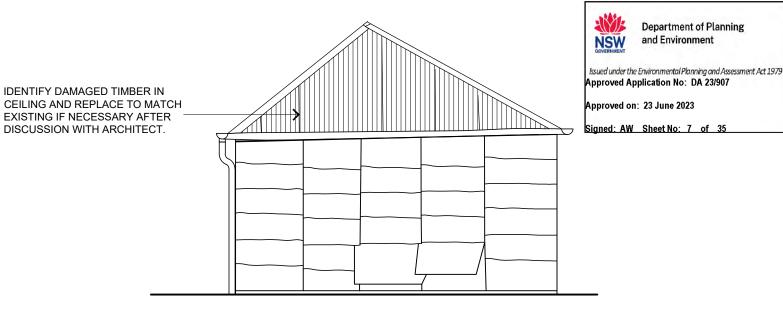

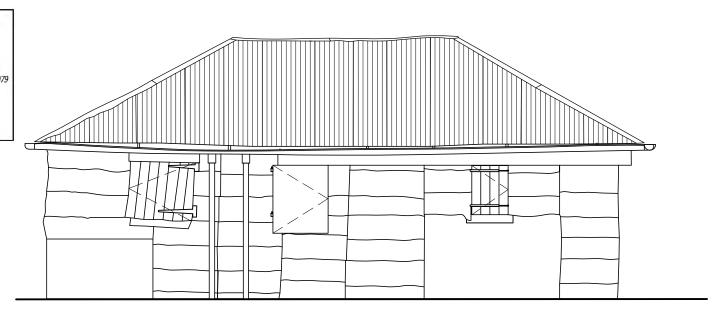

**SOUTH ELEVATION** WEATHERBOARD COTTAGE SCALE: 1:50

**WEST ELEVATION** WEATHERBOARD COTTAGE SCALE: 1:50

Department of Planning

200MM

and Environment

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PROJECT TITLE HADLEY PARK STAGE 1

14-278 OLD CASTLEREAGH ROAD, CASTLEREAGH, NSW 2749

DEPARTMENT OF PLANNING, INDUSTRY WEATHERBOARD COTTAGE **ELEVATIONS** 

> 1:50 MS JΡ DRAWING No. REVISION 2110 WD301 H

USE FIGURED DIMENSIONS IN PREFERENCE TO SCALING.
100 CHECK ALL DIMENSIONS ON SITE.




HISTORIC IMAGE

WEATHERBOARD COTTAGE NORTHEAST CORNER SHOWING CHIMNEY c.1950 IMAGE COURTESY OF FAMILY.



HISTORIC IMAGE

FRONT GATE FORMER LOCATION AT FRONT GARDEN, 1986 IMAGE COURTESY OF PENRITH CITY LIBRARY

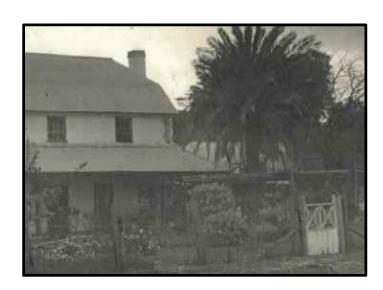

HISTORIC IMAGE

FRONT GATE FORMER LOCATION AT FRONT GARDEN, c.1900 IMAGE COURTESY OF PENRITH CITY LIBRARY



STORED ELEMENTS OF GATE

FRONT GATE CURRENTLY IN GUESTHOUSE, 2022



200MM

**OVERVIEW** CHIMNEY PIECE TO SITTING ROOM, 2019 **NORTHERN WALL** 



DETAIL IMAGES OPENING JOINTS OF CHIMNEY PIECE, 2019 **NORTHERN WALL** 





**DETAIL IMAGES** SACRIFICIAL RENDER EXTERNAL AND INTERNAL



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AND ENVIRONMENT PROJECT TITLE HADLEY PARK STAGE 1

14-278 OLD CASTLEREAGH ROAD,

CASTLEREAGH, NSW 2749

DEPARTMENT OF PLANNING, INDUSTRY REFERENCE IMAGES - GATE, CHIMNEYS AND RENDER

> NTS ES JΡ 2110 WD302 F

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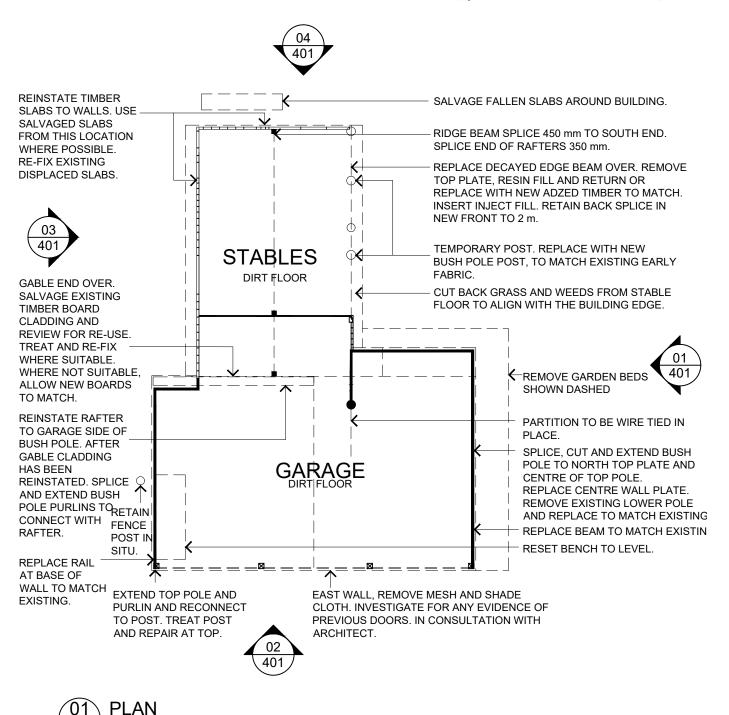
13/07/22 ISSUE FOR REVIEW 01/08/22 FINAL DRAFT FOR REVIEW 24/08/22 CONSULTANT COORDINATION 13/10/22 SECTION 60 APPLICATION


08/12/22 DEVELOPMENT APPLICATION

MS MS

USE FIGURED DIMENSIONS IN PREFERENCE TO SCALING.
100 CHECK ALL DIMENSIONS ON SITE.





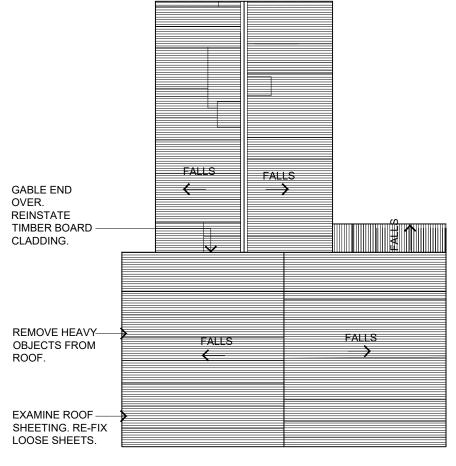

# NOTES:

# GENERAL:

SPLICE OR MAKE GOOD END GRAIN TO VERTICAL POSTS. THEN LEAD CAP EXTERNALLY TO STOP WATER PENETRATION. REPLACE RAIL AT BASE OF SOUTH WALL. CLEAN OUT WHITE ANT DIRT. ADDRESS GROUND LEVELS TO WEST. ADJUST SOIL LEVELS SO THAT THERE IS A POSITIVE FALL AWAY FROM THE BUILDING ON ALL

# ROOF:

SPLICE AND EXTEND GARAGE RIDGE BEAM. ALLOW 1.2 m LENGTH. PLUG RAFTERS AS NEED TO RETAIN RAFTERS. SOLDER HOLES IN ROOF SHEETING. PATCH 6 LARGER HOLES. SPLICE AND EXTEND 5 PURLINS TO EAST END. CLEAN RAFTERS AND INSPECT TO DETERMINE INTEGRITY. REPLACE DAMAGED ROOF SHEETS WITH SALVAGED MATERIAL. TREAT EXISTING ROOF SHEETING WITH 'PENETROL' OR SIMILAR.



200MM



$\subset$	GENERAL NOTES
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	levels, heights and dimensions on site. Contractor is to locate and
	identify existing services on the site and to protect these from
	damage throughout the duration of the works. Any errors,

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STABLES AND GARAGE

REV	ISION		
Α	15/02/22	FOR INFORMATION	
В	02/06/22	50% ISSUE	MS
С	13/07/22	ISSUE FOR REVIEW	ES
D	04/08/22	NOTES UPDATED	MS
Ε	24/08/22	CONSULTANT COORDINATION	MS
F	13/10/22	SECTION 60 APPLICATION	MS
G	08/12/22	CONSULTANT INFORMATION	MS
Н	14/12/22	DEVELOPMENT APPLICATION	MS



SUITE C2.09 22-36 MOUNTAIN STREET ULTIMO NSW 200 TEL: (02) 9211 221 WWW.JPAD.COM.A

14-278 OLD CASTLEREAGH ROAD, CASTLEREAGH, NSW 2749

HADLEY PARK STAGE 1

AND ENVIRONMENT


PROJECT TITLE


DEPARTMENT OF PLANNING, INDUSTRY STABLES AND GARAGE

PLAN 1:100 А3 MS WD400 H 2110


**A3** USE FIGURED DIMENSIONS IN PREFERENCE TO SCALING. 100 CHECK ALL DIMENSIONS ON SITE.



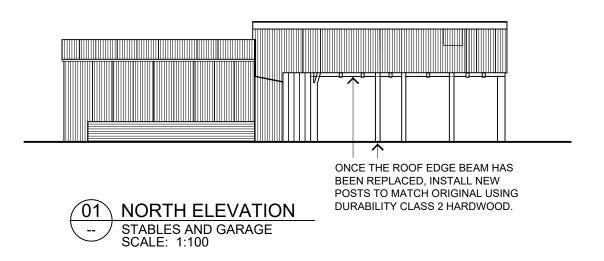

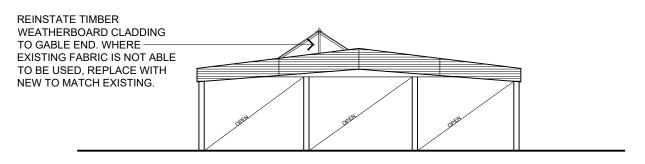



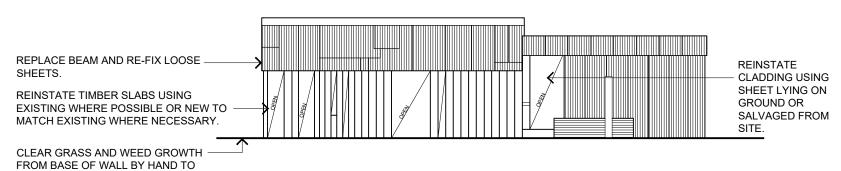

EXAMINE ROOF SHEETING AND RE-FIX ANY LOOSE SHEETS. REMOVE HEAVY OBJECTS FROM ROOF. SALVAGE TIMBER ON **GROUND FOR** REINSTATEMENT.



WEST ELEVATION STABLES AND GARAGE SCALE: 1:100

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GENERAL NOTES

ALLOW THOROUGH ASSESSMENT.

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# ARCHITECTURE INTERIORS HERITAGE

SUITE C2.09 22-36 MOUNTAIN STREET ULTIMO NSW 200 TEL: (02) 9211 221 WWW.JPAD.COM.A


14-278 OLD CASTLEREAGH ROAD, CASTLEREAGH, NSW 2749

HADLEY PARK STAGE 1

AND ENVIRONMENT

PROJECT TITLE

DEPARTMENT OF PLANNING, INDUSTRY STABLES AND GARAGE **ELEVATIONS** 

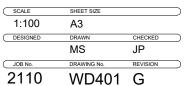

USE FIGURED DIMENSIONS IN PREFERENCE TO SCALING.
100 CHECK ALL DIMENSIONS ON SITE.




NOTES:

ROOF:

REINSTATE CEILING JOISTS IN EXISTING CUT OUTS TO CREAMERY ROOF.

METAL CLADDING TO SKILLION ROOF AND RACK WAS BENT TO EXISTING FORM. THIS FORM IS TO BE RETAINED WHEN REPLACING STRUCTURAL MEMBERS. ALLOW TEMPORARY PROPPING AS NECESSARY.

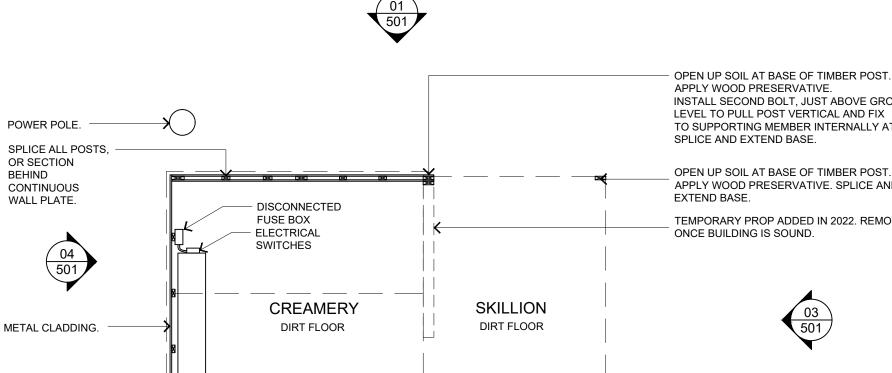


OPEN UP SOIL AT BASE OF TIMBER POST. INSTALL SECOND BOLT, JUST ABOVE GROUND LEVEL TO PULL POST VERTICAL AND FIX TO SUPPORTING MEMBER INTERNALLY AT BASE.

APPLY WOOD PRESERVATIVE. SPLICE AND

TEMPORARY PROP ADDED IN 2022. REMOVE

ALLOW TO RECONSTRUCT OPEN RACK. LABEL AND DISMANTLE COLLAPSING MEMBERS, STORE SECURELY ON SITE. REVIEW CONDITION FOR RE-USE. ALLOW TO LIFT, SPLICE AND SCARF MEMBERS AS NEED TO REINSTATE.

200MM

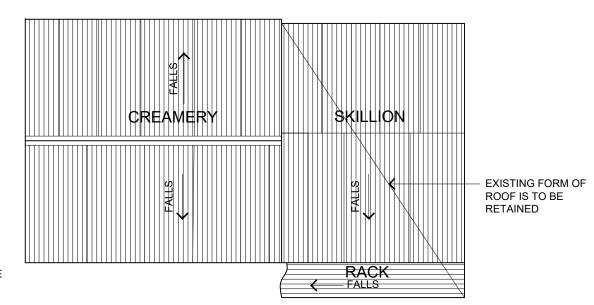



RACK



SEPARATE CUPBOARD FROM DIRT FLOOR TO

MINIMISE FURTHER DAMAGE. REPLACE SEVERELY DAMAGED ELEMENTS TO MATCH EXISTING.





(	GENERAL NOTES
	All building work to comply with relevant Australian Standards.  No dimensions to be scaled or scanned from drawing.
	All dimensions to be checked on site prior to manufacture and construction. Figured dimensions to be used at all times.
	Contractor is responsible for correct setting out with particular reference to boundaries, building lines, etc. Contractor to verify all
	levels, heights and dimensions on site. Contractor is to locate and identify existing services on the site and to protect these from damage throughout the duration of the works. Any errors,
	discrepancies or omissions to be reported to architect immediately. Any queries arising from the above must be reported and clarified

FENCE POST.

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SPLICE AND EXTEND

INNER POST.

02/06/22 50% ISSUE 13/07/22 ISSUE FOR REVIEW
24/08/22 CONSULTANT COORDINATION 13/10/22 SECTION 60 APPLICATION 14/12/22 DEVELOPMENT APPLICATION

ARCHITECTURE INTERIORS HERITAGE

SUITE C2.09 22-36 MOUNTAIN STREET ULTIMO NSW 200 TEL: (02) 9211 221: AND ENVIRONMENT WWW.JPÁD.COM.A

PROJECT TITLE

HADLEY PARK STAGE 1


PROJECT ADDRESS 14-278 OLD CASTLEREAGH ROAD, CASTLEREAGH, NSW 2749


DEPARTMENT OF PLANNING, INDUSTRY CREAMERY PLAN 1:50 A3 DESIGNED CHECKED JP MB JOB No. REVISION

A3 USE FIGURED DIMENSIONS IN PREFERENCE TO SCALING. 100 CHECK ALL DIMENSIONS ON SITE.


300MM ON ORIGINAL

2110 WD500 G

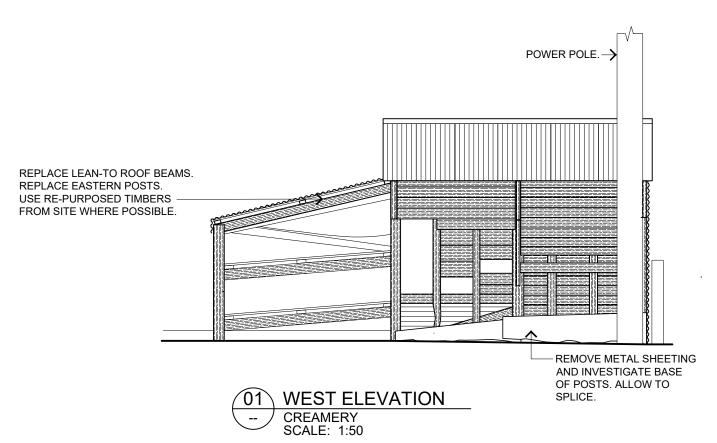


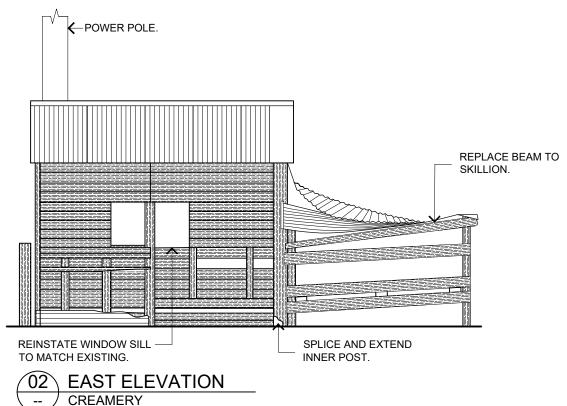




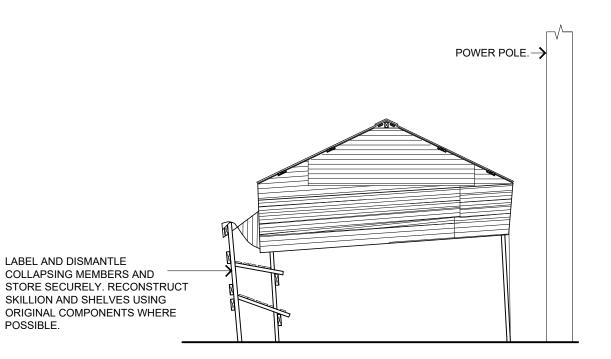



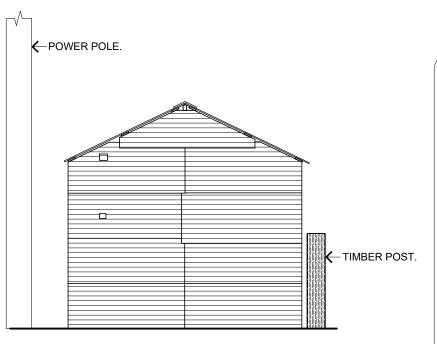

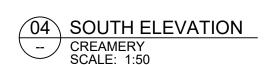

SCALE: 1:50

NOTES: **GENERAL**: ALLOW POLE DIFFUSERS TO ALL POLES IN GROUND, NEW AND EXISTING. APPLY WOOD PRESERVATIVE TO ALL EXPOSED ENDS OF TIMBER. REPLACE MISSING AND SEVERELY DAMAGED WEATHERBOARDS TO MATCH EXISTING. REPLACE DECAYED POSTS ON EAST AND WEST FACING WALLS. REPLACE BEAMS TO SKILLION. REPLACE LEAN TO ROOF BEAMS. TREAT ROOF WITH 'PENETROL'. REINSTATE CEILING JOISTS IN EXISTING CUT OUTS TO CREAMERY ROOF. METAL CLADDING TO SKILLION ROOF AND RACK WAS BENT TO EXISTING FORM. THIS FORM IS TO BE RETAINED WHEN REPLACING STRUCTURAL MEMBERS. ALLOW TEMPORARY PROPPING AS NECESSARY.



DEPARTMENT OF PLANNING, INDUSTRY AND ENVIRONMENT PROJECT TITLE

CREAMERY **ELEVATIONS** 

HADLEY PARK STAGE 1 1:50 A3 PROJECT ADDRESS CHECKED JΡ 14-278 OLD CASTLEREAGH ROAD, REVISION CASTLEREAGH, NSW 2749 2110 WD501 G

All building work to comply with relevant Australian Standards. No dimensions to be scaled or scanned from drawing. All dimensions to be checked on site prior to manufacture and construction. Figured dimensions to be used at all times.

POSSIBLE.

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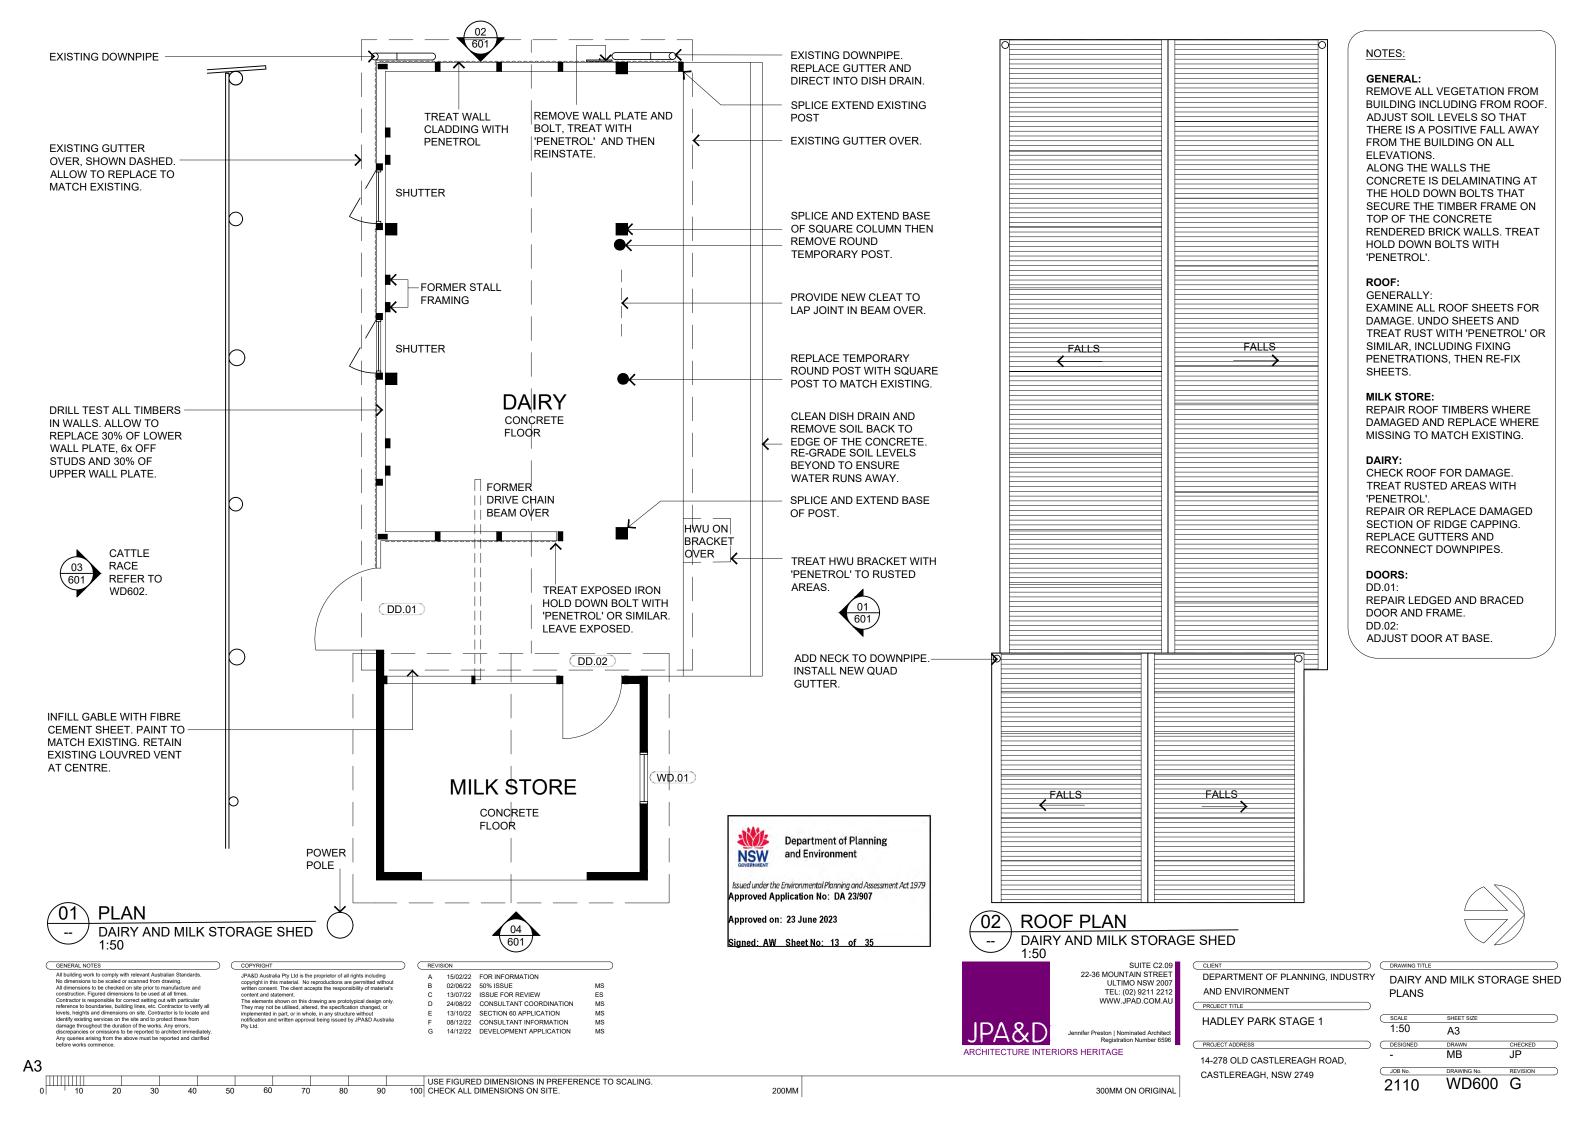
The elements shown on this drawing are prototypical design only


15/02/22 FOR INFORMATION


02/06/22 50% ISSUE 13/07/22 ISSUE FOR REVIEW 24/08/22 CONSULTANT COORDINATION 13/10/22 SECTION 60 APPLICATION

14/12/22 DEVELOPMENT APPLICATION

USE FIGURED DIMENSIONS IN PREFERENCE TO SCALING. 100 CHECK ALL DIMENSIONS ON SITE.



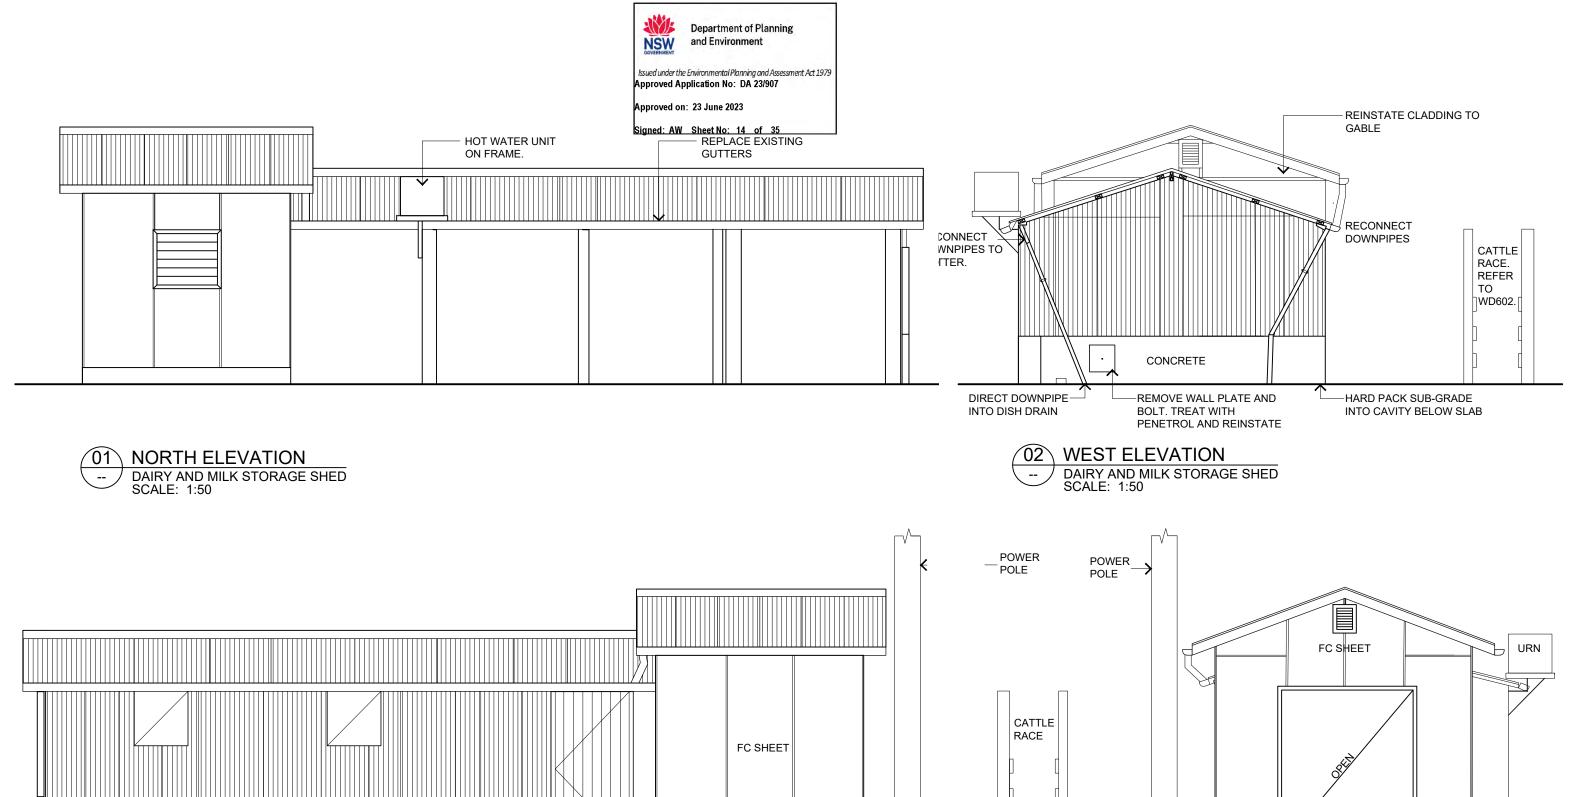

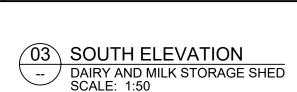

GENERAL NOTES

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CONCRETE

REV	ISION		
Α	15/02/22	FOR INFORMATION	
В	02/06/22	50% ISSUE	MS
С	13/07/22	ISSUE FOR REVIEW	ES
D	24/08/22	CONSULTANT COORDINATION	MS
Е	13/10/22	SECTION 60 APPLICATION	MS
F	08/12/22	CONSULTANT INFORMATION	MS
G	14/12/22	DEVELOPMENT APPLICATION	MS

# **EAST ELEVATION** DAIRY AND MILK STORAGE SHED SCALE: 1:50



SUITE C2.09 22-36 MOUNTAIN STREET ULTIMO NSW 2007 TEL: (02) 9211 2212 WWW.JPAD.COM.AI

PROJECT ADDRESS
14-278 OLD CASTLEREAGH ROAD,
CASTLEREAGH, NSW 2749

HADLEY PARK STAGE 1


AND ENVIRONMENT


PROJECT TITLE

DEPARTMENT OF PLANNING, INDUSTRY DAIRY AND MILK STORAE SHED **ELEVATIONS** 

SCALE	SHEET SIZE	
1:50	A3	
DESIGNED	DRAWN	CHECKED
	MS	.IP
	IVIO	O1
JOB No.	DRAWING No.	REVISION

USE FIGURED DIMENSIONS IN PREFERENCE TO SCALING.
100 CHECK ALL DIMENSIONS ON SITE.

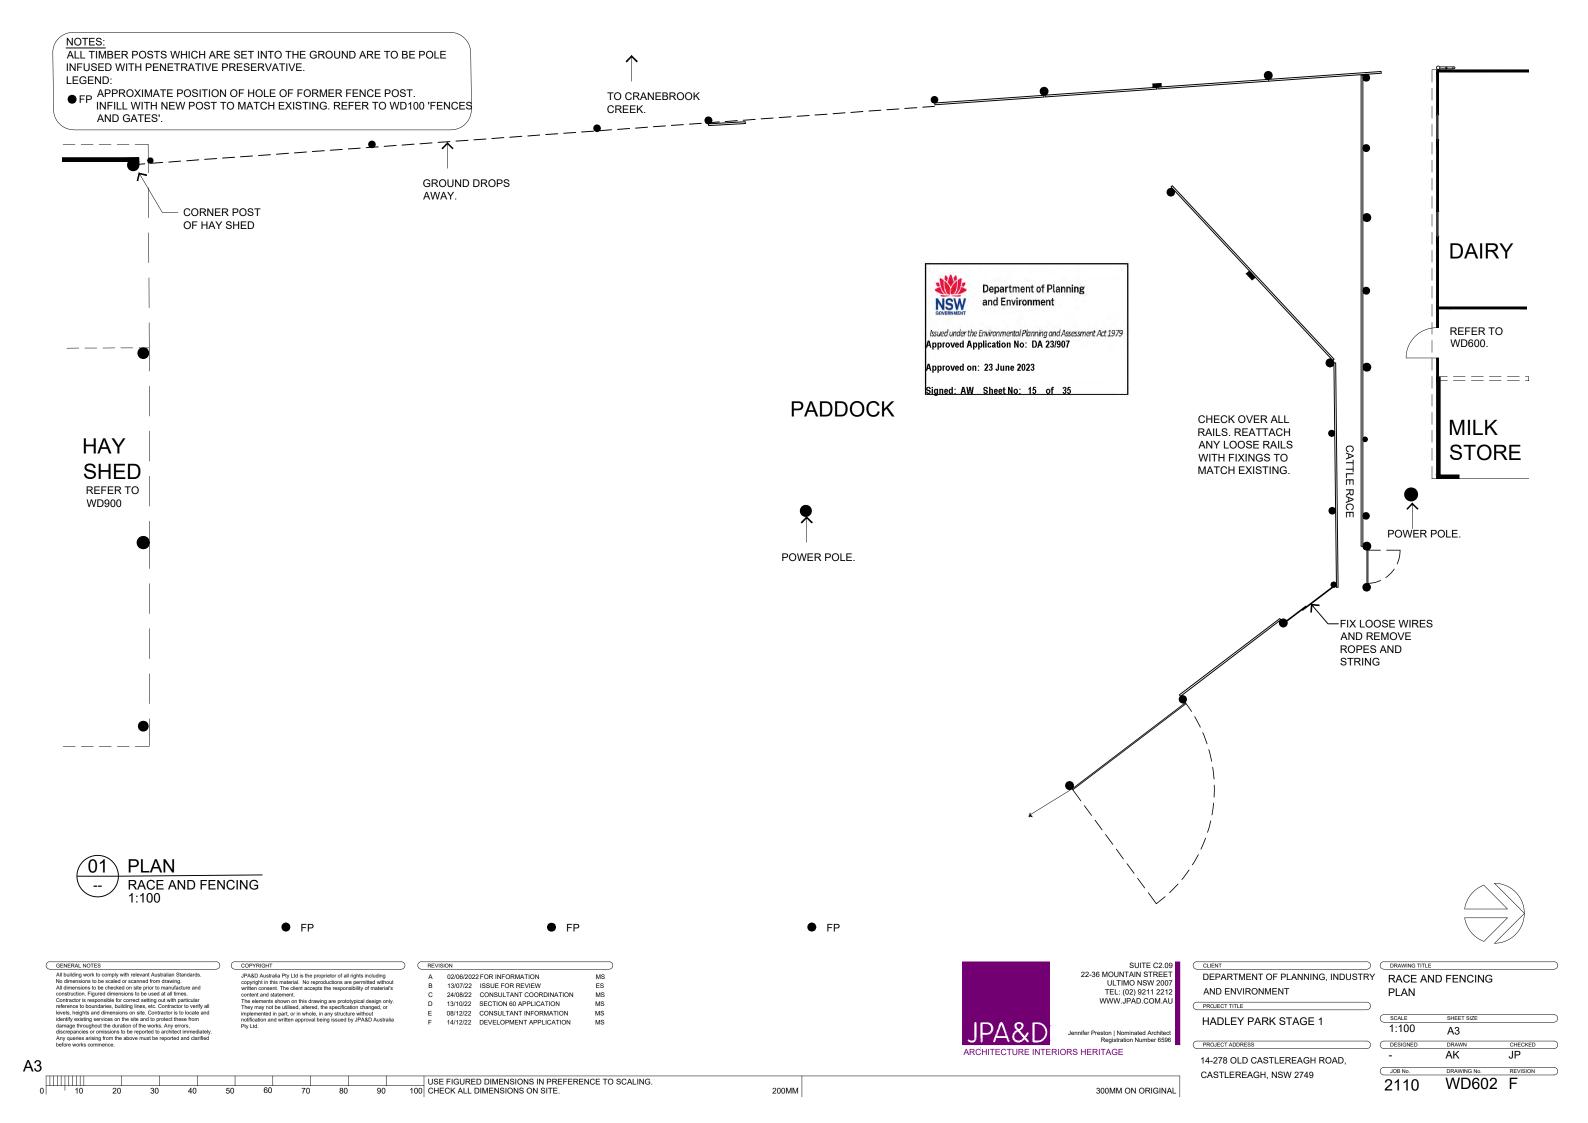

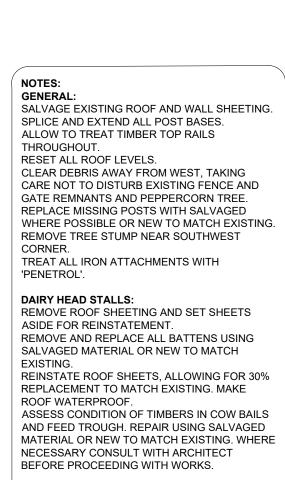

# **FEED STORAGE SHED:**

RECORD MATERIAL ON GROUND SURFACE. RELOCATE MOVEABLE ITEMS IN CONSULTATION WITH ARCHITECT. RE-GRADE GROUND TO FALL TOWARDS THE EAST.

ALLOW TO REPLACE 40% OF ALL BATTENS AND REPAIR 60%. SPLICE RIDGE BEAM AT END AND REPAIR AS NECESSARY. REPLACE 3 RAFTERS. CHECK OVER REMAINDER.


# STORAGE SHED 1:


ALLOW TO REPLACE ALL BATTENS AND 4 RAFTERS.

# STORAGE SHED 2:

**ALLOW TO REPLACE 20% OF BATTENS AND 3 RAFTERS** 



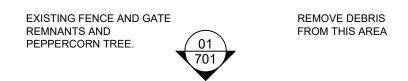

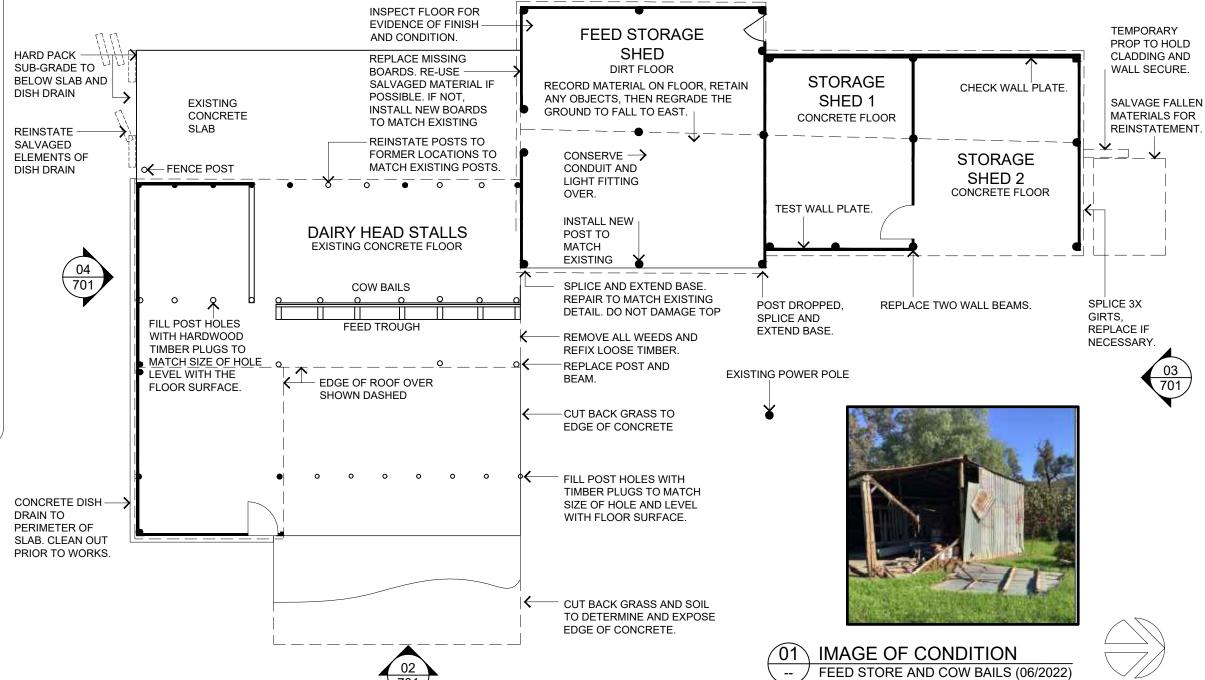



PLAN

FEED STORE AND COW BAILS 1:100

SEE WD702 FOR ROOF PLAN.

GENERÁN NOTES

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15/02/22 FOR INFORMATION 02/06/22 50% ISSUE 13/07/22 ISSUE FOR REVIEW 24/08/22 CONSULTANT COORDINATION 13/10/22 SECTION 60 APPLICATION 14/12/22 DEVELOPMENT APPLICATION

ARCHITECTURE INTERIORS HERITAGE

200MM

SUITE C2.09 22-36 MOUNTAIN STREET ULTIMO NSW 200 WWW.JPAD.COM.A

14-278 OLD CASTLEREAGH ROAD CASTLEREAGH, NSW 2749

HADLEY PARK STAGE 1

AND ENVIRONMENT

PROJECT TITLE


DEPARTMENT OF PLANNING, INDUSTRY FEED STORE AND COW BAILS PI AN

> 1:100 А3 MB WD700 G 2110

USE FIGURED DIMENSIONS IN PREFERENCE TO SCALING 100 CHECK ALL DIMENSIONS ON SITE.

300MM ON ORIGINAL

**A3** 

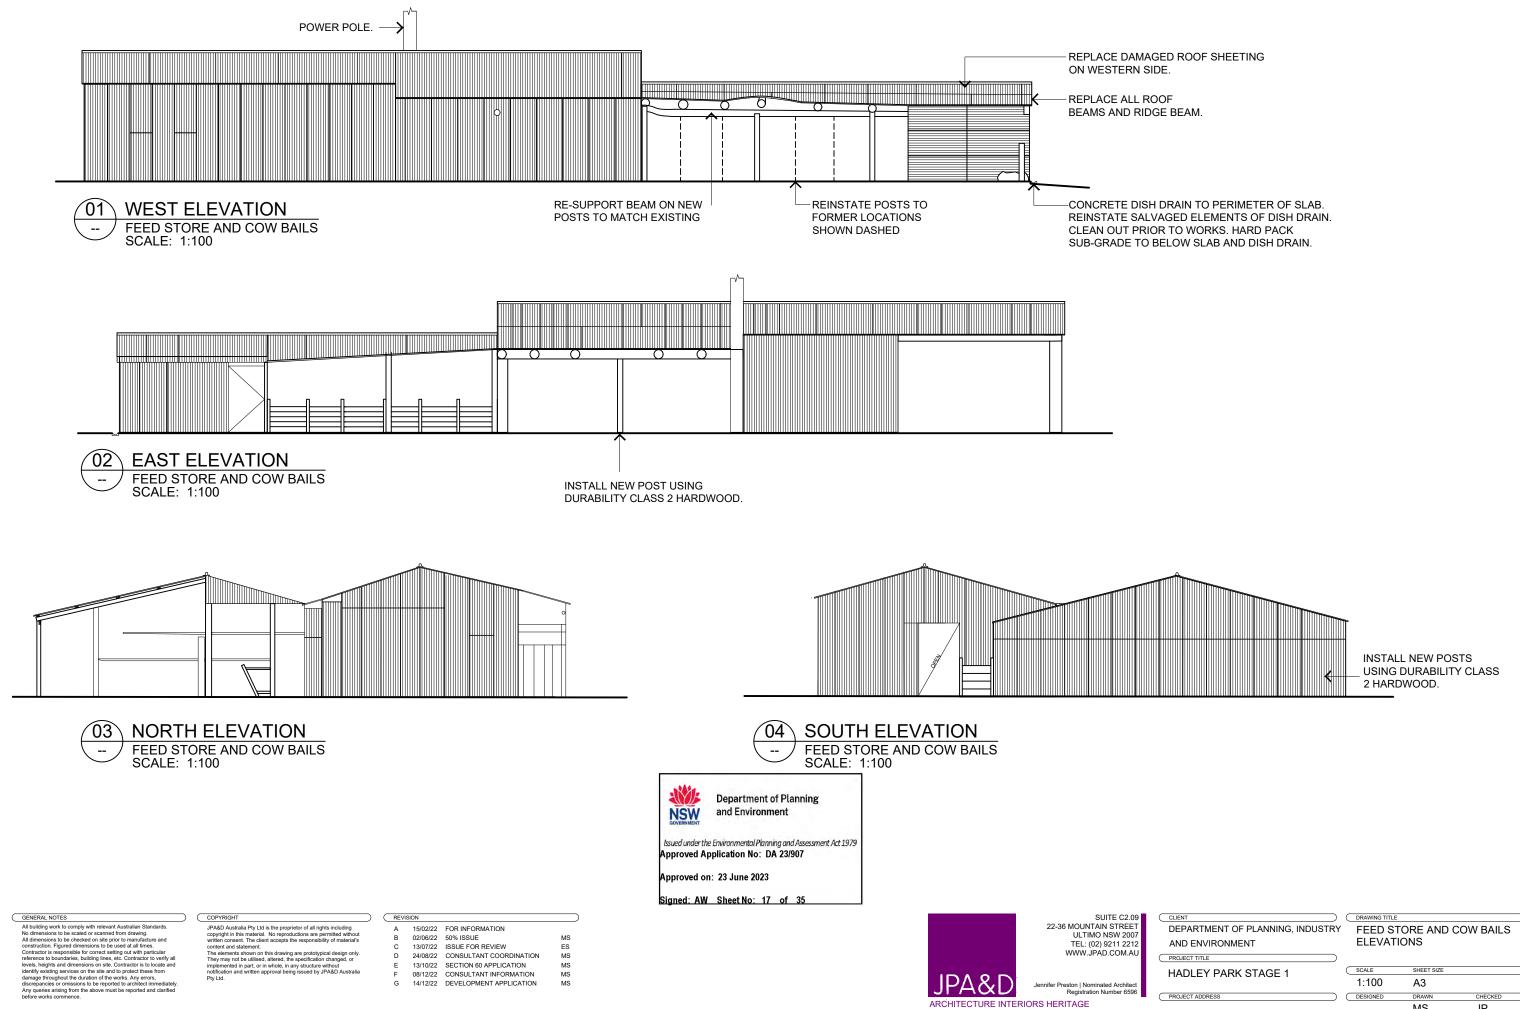

USE FIGURED DIMENSIONS IN PREFERENCE TO SCALING.
100 CHECK ALL DIMENSIONS ON SITE.

300MM ON ORIGINAL


14-278 OLD CASTLEREAGH ROAD, CASTLEREAGH, NSW 2749 2110

MS JΡ DRAWING No. WD701 G



Signed: AW Sheet No: 18 of 35



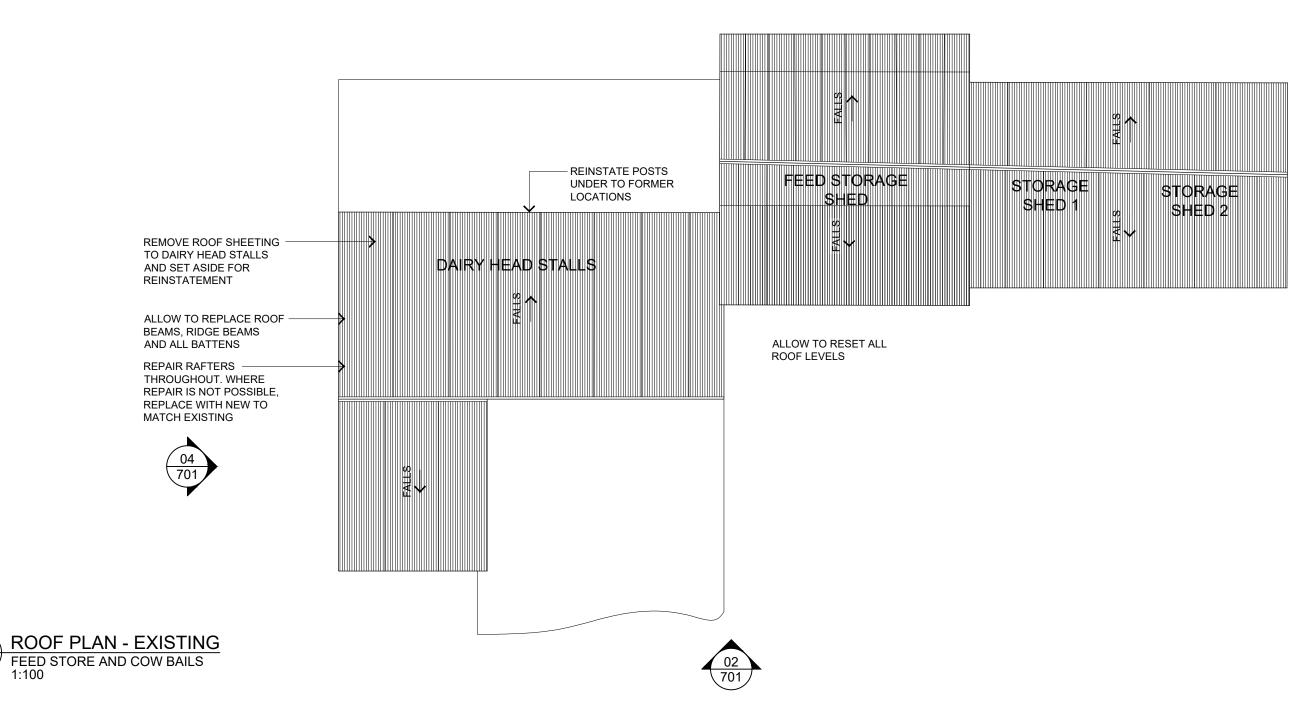

200MM

GENERAL NOTES

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1:100

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ARCHITECTURE INTERIORS HERITAGE

SUITE C2.09 22-36 MOUNTAIN STREET ULTIMO NSW 2007 TEL: (02) 9211 2212 WWW.JPAD.COM.AI


HADLEY PARK STAGE 1

14-278 OLD CASTLEREAGH ROAD, CASTLEREAGH, NSW 2749

AND ENVIRONMENT

PROJECT TITLE

DRAWING TITLE DEPARTMENT OF PLANNING, INDUSTRY FEED STORE AND COW BAILS **ROOF PLAN** 

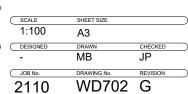


A3 USE FIGURED DIMENSIONS IN PREFERENCE TO SCALING.
100 CHECK ALL DIMENSIONS ON SITE.




NOTES:

THE GUEST HOUSE BUILDING IS TO BE DEMOLISHED. ALLOW TO DISCONNECT AND CAP EXISTING SERVICES. RECORD LOCATIONS FOR POSSIBLE FUTURE USE.



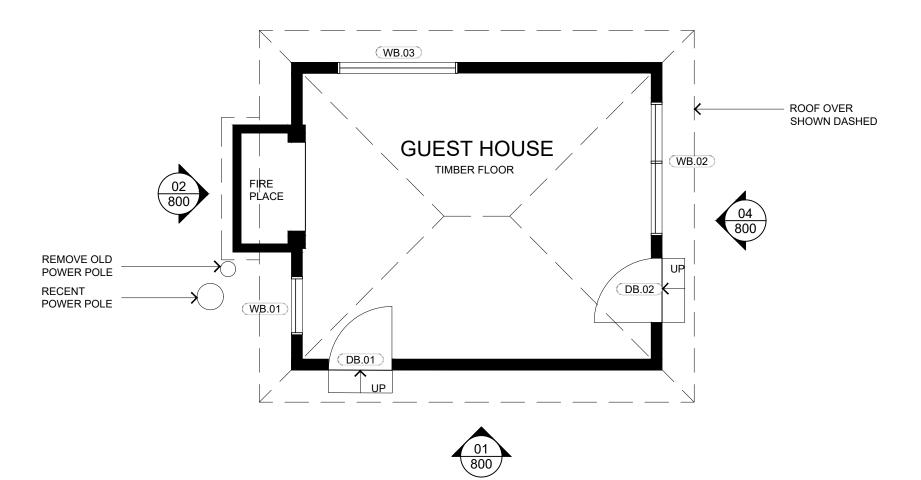

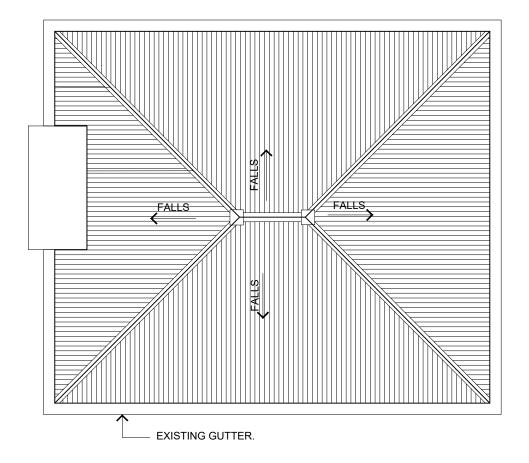

PLAN - EXISTING GUEST HOUSE 1:50







200MM

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ARCHITECTURE INTERIORS HERITAGE

HADLEY PARK STAGE 1

14-278 OLD CASTLEREAGH ROAD,

AND ENVIRONMENT

DEPARTMENT OF PLANNING, INDUSTRY GUEST HOUSE PLAN - EXISTING 1:50 А3

A3 USE FIGURED DIMENSIONS IN PREFERENCE TO SCALING.

100 CHECK ALL DIMENSIONS ON SITE.

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300MM ON ORIGINAL

CASTLEREAGH, NSW 2749


PROJECT TITLE

MB WD800 H 2110






GUESTHOUSE

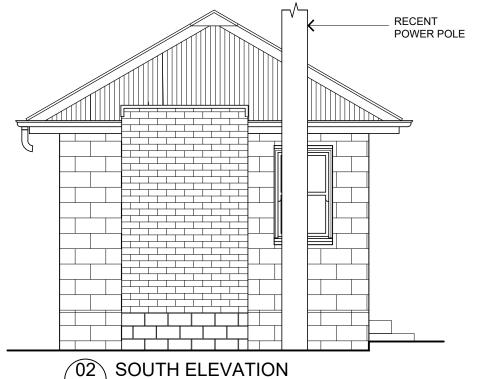

# NOTES:

THE GUEST HOUSE BUILDING IS TO BE DEMOLISHED. ALLOW TO DISCONNECT AND CAP EXISTING SERVICES. RECORD LOCATIONS FOR POSSIBLE FUTURE USE.

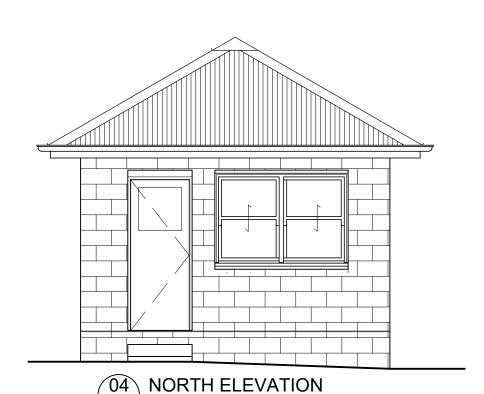

GUESTHOUSE SCALE: 1:50



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SCALE: 1:50

13/07/22 ISSUE FOR REVIEW ES ES MS MS MS 01/08/22 FINAL DRAFT FOR REVIEW 24/08/22 CONSULTANT COORDINATION 13/10/22 SECTION 60 APPLICATION 08/12/22 CONSULTANT INFORMATION 14/12/22 DEVELOPMENT APPLICATION



GUESTHOUSE SCALE: 1:50

200MM

SUITE C2.09 22-36 MOUNTAIN STREET ULTIMO NSW 200 TEL: (02) 9211 221 WWW.JPAD.COM.AI

14-278 OLD CASTLEREAGH ROAD, CASTLEREAGH, NSW 2749

HADLEY PARK STAGE 1

AND ENVIRONMENT


PROJECT TITLE

DEPARTMENT OF PLANNING, INDUSTRY GUEST HOUSE **ELEVATIONS - EXISTING** 


> 1:50 MS JΡ DRAWING No. REVISION 2110 WD801 H

USE FIGURED DIMENSIONS IN PREFERENCE TO SCALING.
100 CHECK ALL DIMENSIONS ON SITE.



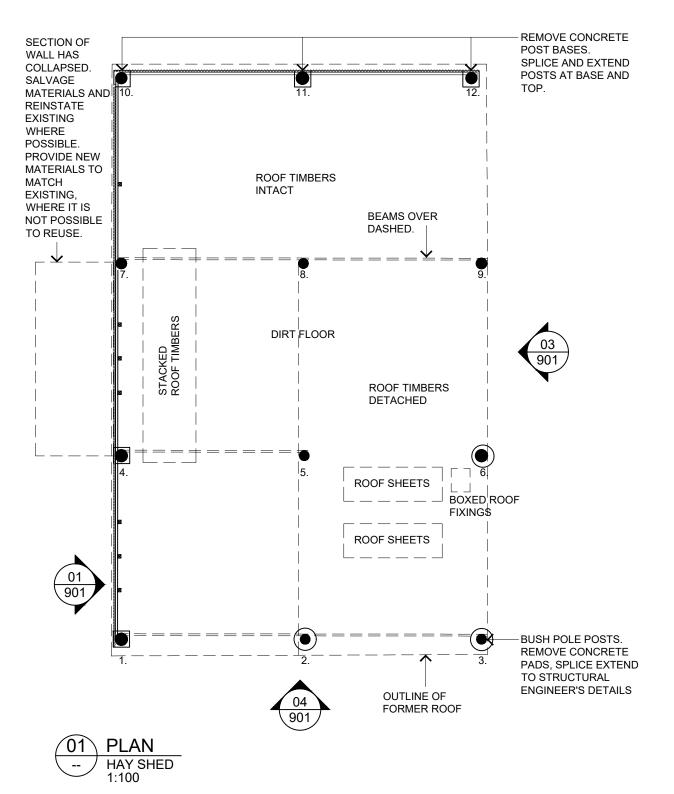

# ALLOW NEW TIMBER BATTENS TO MATCH EXISTING TO WHOLE ROOF

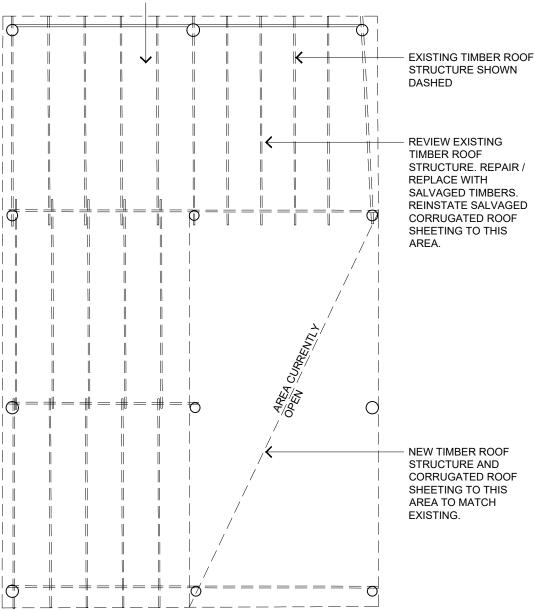

# **GENERAL:**

IN ADDITION TO THOSE NOMINATED ON PLAN. ALLOW TO SPLICE AND EXTEND TOPS OF 5 x POSTS. ALLOW 1.2 m SPLICE AND ADD POLE DIFFUSER TO HOST SPLICE.

REMOVE TREE FROM SOUTH SIDE OF BUILDING. REMOVE GRASS AND VEGETATION IN BUILDING FOOTPRINT. RE-GRADE FLOOR TO PREVIOUS SURFACE.

REPLACE BOTTOM PLATES AND CHECK OVER WALL TIMBERS.

RETAIN ALL IRONMONGERY IN PLACE. TREAT FOR RUST WITH 'PENETROL'.

UNPACK STACKED AND BOXED MATERIALS SALVAGED FROM FORMER ROOF. REVIEW CONDITION FOR RE-USE.

### ROOF:

ROOF IS TO BE REINSTATED TO PREVENT FURTHER DEGRADATION OF BUILDING. SALVAGED TIMBERS ARE TO BE USED WHERE POSSIBLE SOME EXISTING ROOF TIMBERS REMAIN. RE-SHEET THIS PART OF ROOF WITH SALVAGED

INSTALL NEW ROOF STRUCTURE TO MATCH EXISTING TO THE SECTION OF THE ROOF WHICH IS CURRENTLY OPEN, WITH NEW GALVANISED SHEETING. REPLACE ALL BATTENS WITH NEW TO MATCH EXISTING.

REPLACEMENT ROOF SHEETING TO BE SHORT SHEET LENGTHS. ALL ROOF SHEETING TO BE FIXED WITH BUGLE SCREWS. SPLICE AND EXTEND RAFTERS AT EACH END.

ALLOW TO REPLACE 12 RAFTERS. SALVAGE RAFTERS WHERE POSSIBLE. SPLICE AND EXTEND RAFTERS TO SOUTH EDGE OF ROOF. TREAT ROOF SHEETING WITH 'PENETROL'.



NOTE: ROOF CURRENTLY NOT INTACT.





200MM

**IMAGE OF CONDITION** 

HAY SHED (12/2022)

ARCHITECTURE INTERIORS HERITAGE

SUITE C2.09 22-36 MOUNTAIN STREET ULTIMO NSW 200 TEL: (02) 9211 221 WWW.JPÁD.COM.A

HADLEY PARK STAGE 1

PROJECT TITLE

PROJECT ADDRESS 14-278 OLD CASTLEREAGH ROAD, CASTLEREAGH, NSW 2749

AND ENVIRONMENT

DEPARTMENT OF PLANNING, INDUSTRY HAY SHED PLANS **GROUND AND ROOF** 

> 1:100 A3 DESIGNED JOB No. WD900 H 2110

USE FIGURED DIMENSIONS IN PREFERENCE TO SCALING 100 CHECK ALL DIMENSIONS ON SITE.

15/02/22 FOR INFORMATION

13/07/22 ISSUE FOR REVIEW 01/08/22 FINAL DRAFT FOR REVIEW

24/08/22 CONSULTANT COORDINATION


08/12/22 CONSULTANT INFORMATION DEVELOPMENT APPLICATION


SECTION 60 APPLICATION

MS

02/06/22 50% ISSUE


All building work to comply with relevant Australian Standards. No dimensions to be scaled or scanned from drawing. All dimensions to be checked on site prior to manufacture and construction. Figured dimensions to be used at all times.

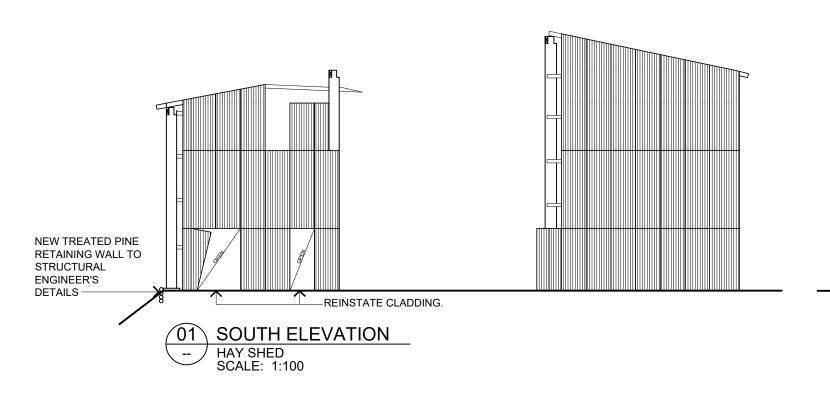


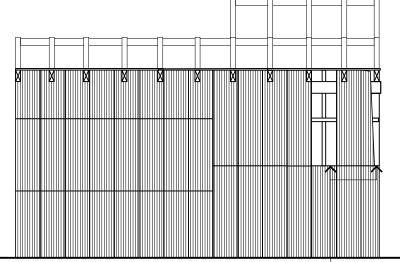

REINSTATE CLADDING.-

**WEST ELEVATION** HAY SHED SCALE: 1:100

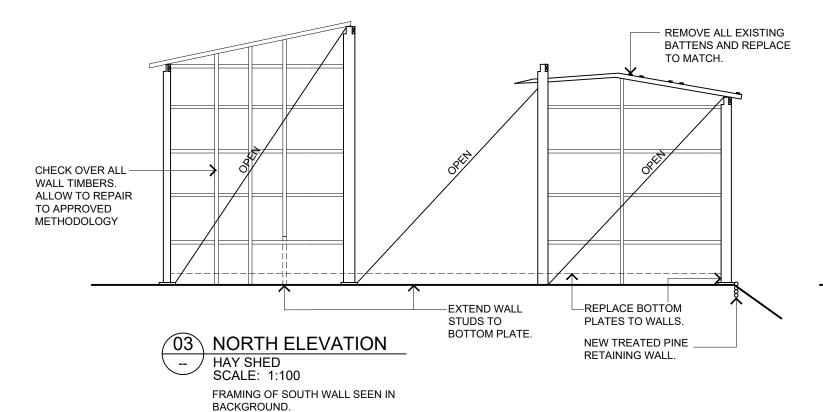

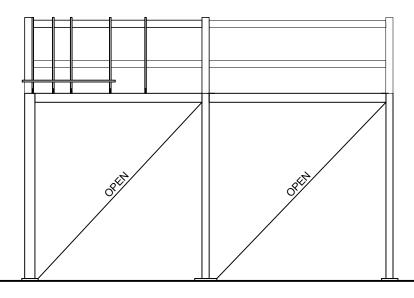

**EAST ELEVATION** HAY SHED SCALE: 1:100

200MM

# GENERAL:

IN ADDITION TO THOSE NOMINATED ON PLAN, ALLOW TO SPLICE AND EXTEND TOPS OF 5 x POSTS. ALLOW 1.2 m SPLICE AND ADD POLE DIFFUSER TO HOST SPLICE.

REMOVE TREE FROM SOUTH SIDE OF BUILDING. REMOVE GRASS AND VEGETATION IN BUILDING FOOTPRINT. RE-GRADE FLOOR TO PREVIOUS SURFACE.

REPLACE BOTTOM PLATES AND CHECK OVER WALL TIMBERS.

RETAIN ALL IRONMONGERY IN PLACE. TREAT FOR RUST WITH 'PENETROL'.

UNPACK STACKED AND BOXED MATERIALS SALVAGED FROM FORMER ROOF. REVIEW CONDITION FOR RE-USE.

### ROOF:

ROOF IS TO BE REINSTATED TO PREVENT FURTHER DEGRADATION OF BUILDING. SALVAGED TIMBERS ARE TO BE USED WHERE POSSIBLE SOME EXISTING ROOF TIMBERS REMAIN. RE-SHEET THIS PART OF ROOF WITH SALVAGED SHEETING.

INSTALL NEW ROOF STRUCTURE TO MATCH EXISTING TO THE SECTION OF THE ROOF WHICH IS CURRENTLY OPEN, WITH NEW GALVANISED SHEETING. REPLACE ALL BATTENS WITH NEW TO MATCH EXISTING.

REPLACEMENT ROOF SHEETING TO BE SHORT SHEET LENGTHS. ALL ROOF SHEETING TO BE FIXED WITH BUGLE SCREWS. SPLICE AND EXTEND RAFTERS AT EACH END.

ALLOW TO REPLACE 12 RAFTERS. SALVAGE RAFTERS WHERE POSSIBLE. SPLICE AND EXTEND RAFTERS TO SOUTH EDGE OF ROOF. TREAT ROOF SHEETING WITH 'PENETROL'



GENERÁL NOTES

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14/12/22 DEVELOPMENT APPLICATION

ARCHITECTURE INTERIORS HERITAGE

SUITE C2.09 22-36 MOUNTAIN STREET ULTIMO NSW 200 TEL: (02) 9211 221 WWW.JPAD.COM.A

PROJECT ADDRESS 14-278 OLD CASTLEREAGH ROAD, CASTLEREAGH, NSW 2749

HADLEY PARK STAGE 1

AND ENVIRONMENT

PROJECT TITLE

DEPARTMENT OF PLANNING, INDUSTRY HAY SHED ELEVATIONS

SCALE SHEET SIZE 1:100 А3 MS JΡ DRAWING No. 2110 WD901 H

USE FIGURED DIMENSIONS IN PREFERENCE TO SCALING.
100 CHECK ALL DIMENSIONS ON SITE.

# WORKS PHILOSOPHY

- WP1 REPAIRS ARE AIMED AT PROVIDING STRUCTURAL STABILITY TO THE BUILDINGS WHILE CONSERVING AND PRESERVING HERITAGE FABRIC.
- WP2. WHERE TIMBER ELEMENTS ARE SCHEDULED TO BE REPLACED THIS IS TO BE DONE ON A LIKE FOR LIKE BASIS INCLUDING DIMENSIONS AND DECORATIVE FEATURES (FOR EXAMPLE : ADZING TO EXPOSED FACES, CHAMFERS, BEVELS
- WP3. ALL NEW TIMBER TO BE SEASONED HARDWOOD FREE OF SPLITS OR DEFECTS.
- WP4. AT SPLICES TRIM AND SHAPE TIMBER TO MATCH ADJACENT ORIGINAL
- WP5. REPAIR DETAILS SHOWN ARE INDICATIVE ONLY. THEY WILL NEED TO BE DIMENSIONALLY ADAPTED TO SUIT SITE GEOMETRY.
- WPS. ALL BOLTS AND BRACKETS EXPOSED TO THE WEATHER OR EMBEDDED IN EXTERNAL WALLS ARE TO BE GRADE 316 STAINLESS STEEL.
- WP6. ALL TIE WIRE AND INTERNAL BOLTS AND BRACKETS TO BE HOT DIP GALVANISED.
- WP7. PRE DRILL WHEN NAILING EXISTING MEMBERS.
- WP8 PROVIDE TEMPORARY PROPPING AND BRACING WHERE NECESSARY TO STABILISE FLEMENTS PRIOR TO AND DURING WORKS.
- WP9. WHERE POSSIBLE EXISTING MATERIAL IS TO BE KEPT IN ITS ORIGINAL LOCATION AND REPAIRED. WHERE SALVAGEABLE MATERIAL MUST BE REMOVED OR REPLACED IT SHOULD BE REUSED ELSE-WHERE IF POSSIBLE.

# TIMBER LINTELS, BEAMS AND HORIZONTAL GROUNDS EMBEDED IN THE WALLS

- TL1. ALL TIMBER LINTELS AND HORIZONTAL GROUNDS SHALL BE EXAMINED. BY CAREFUL PEELING BACK OF FINISHES. WHERE CONDITION IS DOUBTFUL THE TIMBER SHALL BE DRILL TESTED WITH AN 8mm TWIST DRILL TO CHECK FOR VOIDS AND DECAY. REPAIR AND REPLACEMENT SHALL BE AGREED WITH THE ENGINEER
- TL2. REPLACEMENT OF THE TIMBER LINTELS WILL BE BY SUITABLE TEMPORARY PROPPING AND REPLACEMENT WITH SOUND SEASONED HARDWOOD SHAPED AND FINISHED TO MATCH ORIGINAL AND PACKED TIGHT IN PLACE WITH MORTAR TO MATCH ORIGINAL.
- TL3. REPLACEMENT OF TIMBER GROUNDS CAN BE DONE IN DISCRETE LENGTHS WITH HORIZONTAL HALVED SPLICES AT JUNCTIONS. THE SPLICES DO NOT NEED TO BE CONNECTED. THE GROUNDS ARE TO BE SOUND SEASONED HARDWOOD SHAPED AND FINISHED TO MATCH ORIGINAL AND ARE TO BE SET INTO A MORTAR NEED TO BE CONNECTED. THE GROUNDS ARE TO BE SET INTO A MORTAR BACKING AND MORTAR PACKED ALL AROUND.
- TL4. REPLACEMENT TIMBER IS TO BE NEATLY AND DISCRETELY MARKED 2010 BY ENGRAVING OR STAMPING INTO A SUITABLE EXPOSED POSITION
- TLS. FOR ESTIMATING PURPOSES ALLOW FOR REPLACEMENT OF 100 LINEAL METRES OF EMBEDDED TIMBER GROUNDS. PROVIDE A RATE PER LINEAL METRE FOR REPLACEMENT OF GROUNDS TO ALLOW ADJUSTMENT TO COSTS FOR LENGTHS GREATER OR LESS THAN THIS ALLOWANCE.

# TERMITE PROTECTION

TP1. WHERE DISTURBED BY THE WORKS REMOVE AND REPLACE TERMITE BAITING

PGN

PGN

Drawing Completed by

MdC

01.02.22

RE-FORMATTED TO A3

Amendment or reason for issue

PRELIMINARY ISSUE

# GENERAL NOTES

- G1. THESE STRUCTURAL DRAWINGS SHALL BE READ IN CONJUNCTION WITH ALL APPROVAL CONDITIONS, ARCHITECTURAL AND OTHER CONSULTANTS' DRAWINGS AND SPECIFICATIONS AND WITH SUCH OTHER WRITTEN INSTRUCTIONS AS MAY BE ISSUED DURING THE COURSE OF THE CONTRACT. ANY DISCREPANCY SHALL BE REFERRED TO THE STRUCTURAL ENGINEER BEFORE PROCEEDING WITH THE
- G2. ALL MATERIALS AND WORKMANSHIP SHALL BE IN ACCORDANCE WITH SOUND HERITAGE CONSERVATION PRACTICE.
- G3. ALL SET OUT DIMENSIONS SHOWN ON THESE STRUCTURAL DRAWINGS SHALL BE VERIFIED BY THE BUILDER ON SITE. DO NOT SCALE THESE STRUCTURAL DRAWINGS FOR DIMENSIONS.
- G4. UNLESS NOTED OTHERWISE ALL LEVELS ARE IN METRES AND ALL DIMENSIONS ARE IN MILLIMETRES.
- G5. THE METHOD OF CONSTRUCTION AND THE MAINTENANCE OF BUILDING STABILITY SAFETY DURING CONSTRUCTION ARE THE RESPONSIBILITY OF THE BUILDER. IF ANY STRUCTURAL ELEMENT PRESENTS DIFFICULTY IN RESPECT OF CONSTRUCTABILITY OR SAFETY, THE MATTER SHALL BE REFERRED TO THE STRUCTURAL ENGINEER FOR RESOLUTION BEFORE PROCEEDING WITH THE
- G6. DURING CONSTRUCTION THE STRUCTURE SHALL BE PROTECTED AND MAINTAINED IN A STABLE CONDITION AND NO PART SHALL BE OVERLOADED. THE BUILDER SHALL PROVIDE TEMPORARY BRACING, SHORING AND PROPPING IN ORDER TO KEEP THE BUILDING WORKS AND EXCAVATIONS STABLE AT ALL TIMES. ALL TEMPORARY WORKS SHALL BE APPROVED BY THE ARCHITECT AND/OR STRUCTURAL ENGINEER PRIOR TO IMPLEMENTATION.
- G7. THE BUILDER IS RESPONSIBLE FOR THE ADEQUACY OF ALL TEMPORARY WORKS INCLUDING SHORING, PROPPING AND BRACING AND WHERE NECESSARY IS TO ENGAGE A STRUCTURAL ENGINEER TO DESIGN AND CERTIFY HIS
- G8. IF THERE IS A DISCREPANCY IN MEMBER SIZES FOR ANY COMPONENT ASSUME FOR PRICING PURPOSES ONLY THAT THE LARGER OR MORE EXPENSIVE SIZE IS CORRECT. REFER TO STRUCTURAL ENGINEER FOR DECISION BEFORE DETAILING OR CONSTRUCTION.
- G9. DETAIL AND SECTION IDENTIFICATION



- DETAIL OR SECTION REFERENCE

— DRAWING REFERENCE

# TIMBER

- T1. ALL TIMBER DESIGN, MATERIAL AND CONSTRUCTION TO COMPLY WITH AS1170
- TIMBER FRAMING SHALL COMPLY WITH AS1684

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- HARDWOOD TO BE SEASONED MINIMUM GRADE E14 JOINT GRADE IS UNO SUBMIT SUPPLIER'S CERTIFICATE AS TO STRESS GRADE OF TIMBER MEMBERS. ALL TIMBER SHALL BE YEAR MARKED
- T4. EXTERNAL TIMBER SHALL BE HARDWOOD MINIMUM DURABILITY CLASS 1
- ALL SIZES ASSUME NO NOTCHING. ALL JOINTS AND ENDS ARE TO BE A MIN 100mm AWAY FROM ANY TIMBER DEFECTS
- ALL BOLTS IN TIMBER CONSTRUCTION TO BE MINIMUM M16 UNLESS NOTED OTHERWISE BOLT HOLES TO BE DRILLED EXACT BOLT SIZE WASHERS UNDER HEADS AND NUTS TO BE AT LEAST 2.5 TIMES BOLT
- TIMBER TOLERANCES ON THE FINISHED WIDTH AND THICKNESS TO BE IN ACCORDANCE WITH AS2082, AS1748, AS3519 AS APPROPRIATE
- ALL TIMBER JOINTS AND NOTCHES ARE TO BE 100MM MINIMUM AWAY FROM LOOSE KNOTS, SEVERE SLOPING GRAIN, GUM VEINS OR OTHER

# CLAY BRICK MASONRY

- M1. BRICK REPAIRS SHALL BE CARRIED OUT WITH SALVAGED BRICKS FROM SITE OR BRICKS FROM ELSEWHERE OF AS CLOSE A MATCH AS POSSIBLE IN COLOUR, TEXTURE & SIZE. BRICKS TO BE APPROVED BY THE
- M2. EXISTING MORTAR SHALL BE ANALYSED FOR COMPOSITION BY APPROPRIATE TESTING LABRATORY. NEW MORTAR SHALL MATCH EXISTING.
- SALVAGE AND REUSE EXISTING MORTAR SUPPLIMENTED WITH NEW MORTAR
- WHERE SUITABLE BRICKS CAN NOT BE SOURCED THEN THE BUILDER IS TO HAVE BRICKS MANUFACTURED TO MATCH EXISTING. THE BUILDER IS TO PREPARE A SAMPLE OF TEN BRICKS FOR THE ARCHITECTS APPROVAL PRIOR TO MANUFACTURING THE REMAINDER
- ALL MANUFACTURED BRICKS ARE TO BE PERMANENTLY MARKED TO IDENTIFY THEM AS NON-ORIGINAL. THE NATURE OF THE MARK IS TO BE AGREED WITH
- ALL LOOSE FRETTED BRICKWORK IS TO BE REMOVED FROM EXPOSED FACES
- BRICKS WITH LESS THAN 15 mm OF LOSS OF FACE MAY REMAIN IN-SITU IF
- BRICKS WITH MORE THAN 15 mm OF LOSS BUT LESS THAN 30mm OF LOSS MAY BE ROTATED AND RE-USED IF DESALINATED AND SOUND. THE VOID SPACE IS TO BE MADE UP WITH MORTAR
- DESALINATE BRICKS THAT ARE SALVAGED FROM ELSEWHERE.
- AREAS OF MORTAR LOSS ARE TO BE RE-POINTED USING MATCHING MORTAR TO ACHIEVE FULL DEPTH BEARING CONTACT ON BEDS AND PERPENDS, AS INSTRUCTED BY THE SUPERINTENDENT

TENDERERS SHALL ALLOW FOR 10SQM OF RE-POINTING WITH A +/- RATE FOR VARIATION

# BRICK STITCHING

- REMEDIAL BRICK REINFORCING IS TO BE CARRIED OUT USING 6mm STAINLESS STEEL HELIBARS BY HELIFIX FIXED WITH LIME MORTAR, (NOT WITH HELIBOND, CEMENTITOUS MORTARS OR EPOXY MORTARS)
- BS2. BRICK REINFORCING SHOWN ON THE DRAWINGS IS INDICATIVE OF LAYOUT. DETAILED LAYOUT IS TO BE AGREED ON SITE WITH THE STRUCTURAL ENGINEER AND ARCHITECT

# POST SUPPORT

- PS1. MAINTAIN SOUND POSTS AND POST REMNANTS IN-SITU. ALLOW TO PROP AND SUPPORT AS REQUIRED
- PS2. ANY PROPOSED REMOVAL IS TO BE CONFIRMED WITH THE ARCHITECT AND ENGINEER PRIOR TO REMOVAL

# USE OF PROPRIETARY MATERIALS

PM1 ALL PROPRIETARY MATERIALS MUST BE USED STRICTLY ACCORDING TO THE MANUFACTURERS INSTRUCTIONS.

# **EXISTING PROP REMOVAL**

- PROPS SHALL ONLY REMOVED ONCE ALL OF THE REMEDIAL WORKS ARE COMPLETED AND INSPECTED BY THE ENGINEER
- INSERT AN ACROW PROP ADJACENT TO THE PROP TO BE REMOVED AND APPLY SUFFICIENT SCREW PRESSURE TO JUST ALLOW THE EXISTING PROP TO BE REMOVED
- CAREFULLY REMOVE THE EXISTING PROP WITH CAUSING ANY IMPACT
- MONITORING THE STRUCTURE OVER, SLOWLY RELEASE THE ACROW PROP AND CHECK THAT NOW MOVEMENT HAS TAKEN PLACE
- IF ANY MOVEMENT OCCURS, RE-TIGHTEN THE ACROW PROP AND ADVISE THE ENGINEER IMMEDIATELY

# FIRST FLOOR AND ROOF TIMBER FRAMING

- ALL THE TIMBER FLOOR/CEILING JOISTS, BEARERS AND RAFTERS MUST BE INVESTIGATED AND ASSESSED FOR RE-USE PRIOR TO REMOVAL OF ANY OF THE EXISTING PROPS
- FF2. ANY PROP REMOVAL SHALL COMPLY WITH THE PR NOTES ABOVE
- SUBJECT TO THE APPROVAL OF THE ARCHITECT, REMOVE ALL CEILING LININGS (OR FLOOR BOARDS) TO FACILIATE A FULL AND COMPLETE INSPECTION OF THE JOISTS AND BEARERS
- ALL TIMBER MEMBERS SHALL 'SOUNDED' TO DETERMINE ANY LOCALISED AREAS OF DECAY. INDENTIFIED AREAS SHALL BE DRILL RESISTANCE TESTED WITH A <6mm DIAMETER TWIST DRILL
- IF DURING DRILL TESTING AN AREA HAS A DEFECT > DEPTH OR WIDTH BY 20% OF THE OVERALL DIMENSION, THE ENGINEER MUST RF ADVISED. A REPAIR OR SUPPLEMENTATION INSTRUCTION WILL THEN BE ISSUED BY THE ENGINEER
- FOR TENDERING PUPOSES ONLY ALLOW FOR NEW TIMBER MEMBERS: BEARERS: 300x63 LVL

JOISTS: 100x45 LVL 30m RAFTERS: 150x45 LVL AND PROVIDE A +/- RATE FOR VARIATION TO THE ABOVE


ALL NEW TIMBER SHALL BE DATE STAMPED WITH THE YEAR OF INSTALLATION, IN AN EXPOSED YET DISCRETE LOCATION

# MEMBER KEY

- TOP FLOOR BOTTOM FLOOR
- CHAIR RAIL GROUNDS
- SKIRTING GROUNDS
- DECAYED TIMBER

FLEMENTS ARE NUMBERED ON PLAN. BOARDS, JOISTS, RAFTERS ETC ARE NUMBERED FROM NORTH TO SOUTH AND FROM WEST TO EAST (AS APPROPRIATE FOR ORIENTATION)

NOTES

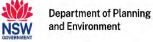

ssued under the Environmental Planning and Assessment Act 🖺 979

Approved Application No: DA 23/907

pproved on: 23 June 2023

North

ducros design Structural & Civil Consulting Engineers

ABN 52 121 404 386


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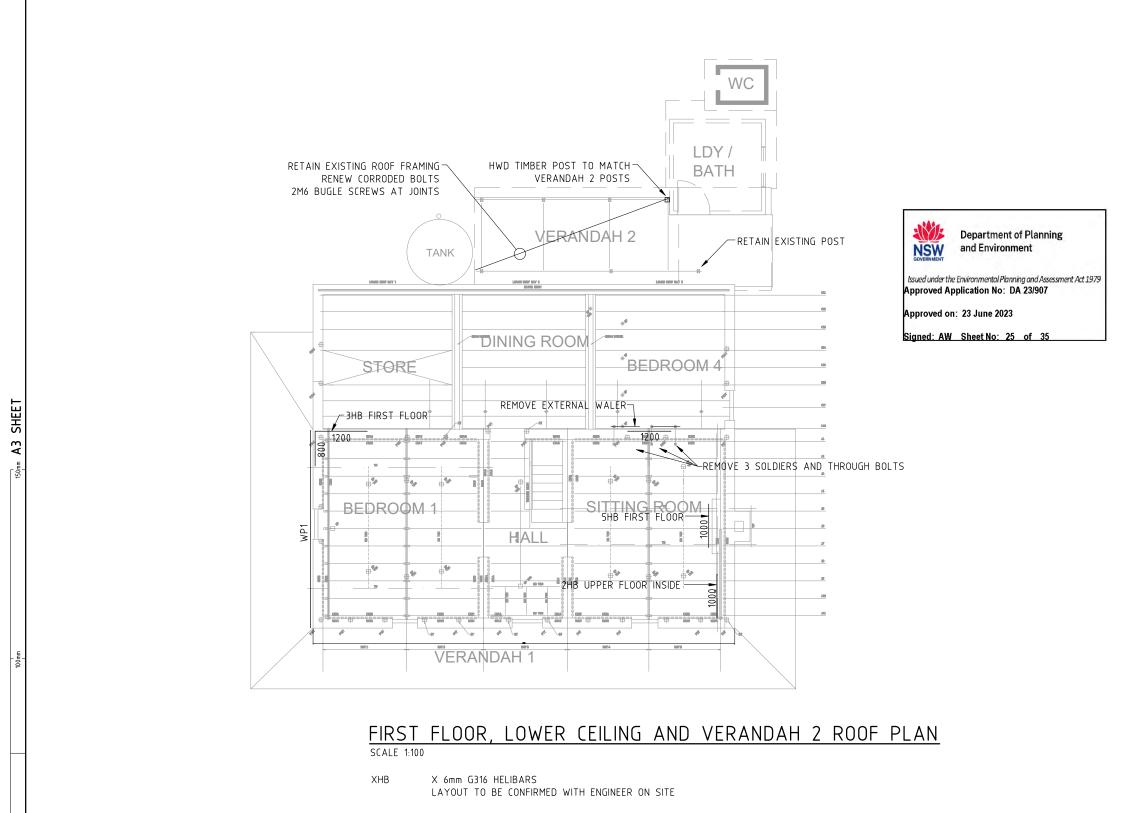
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HADLEY PARK - STAGE 1

113 CASTLEREAGH ROAD

DEPT PLANNING, INDUSTRY & ENVIRONMENT JUNE 2022 1842- S101 1 OF 9 JPA&D



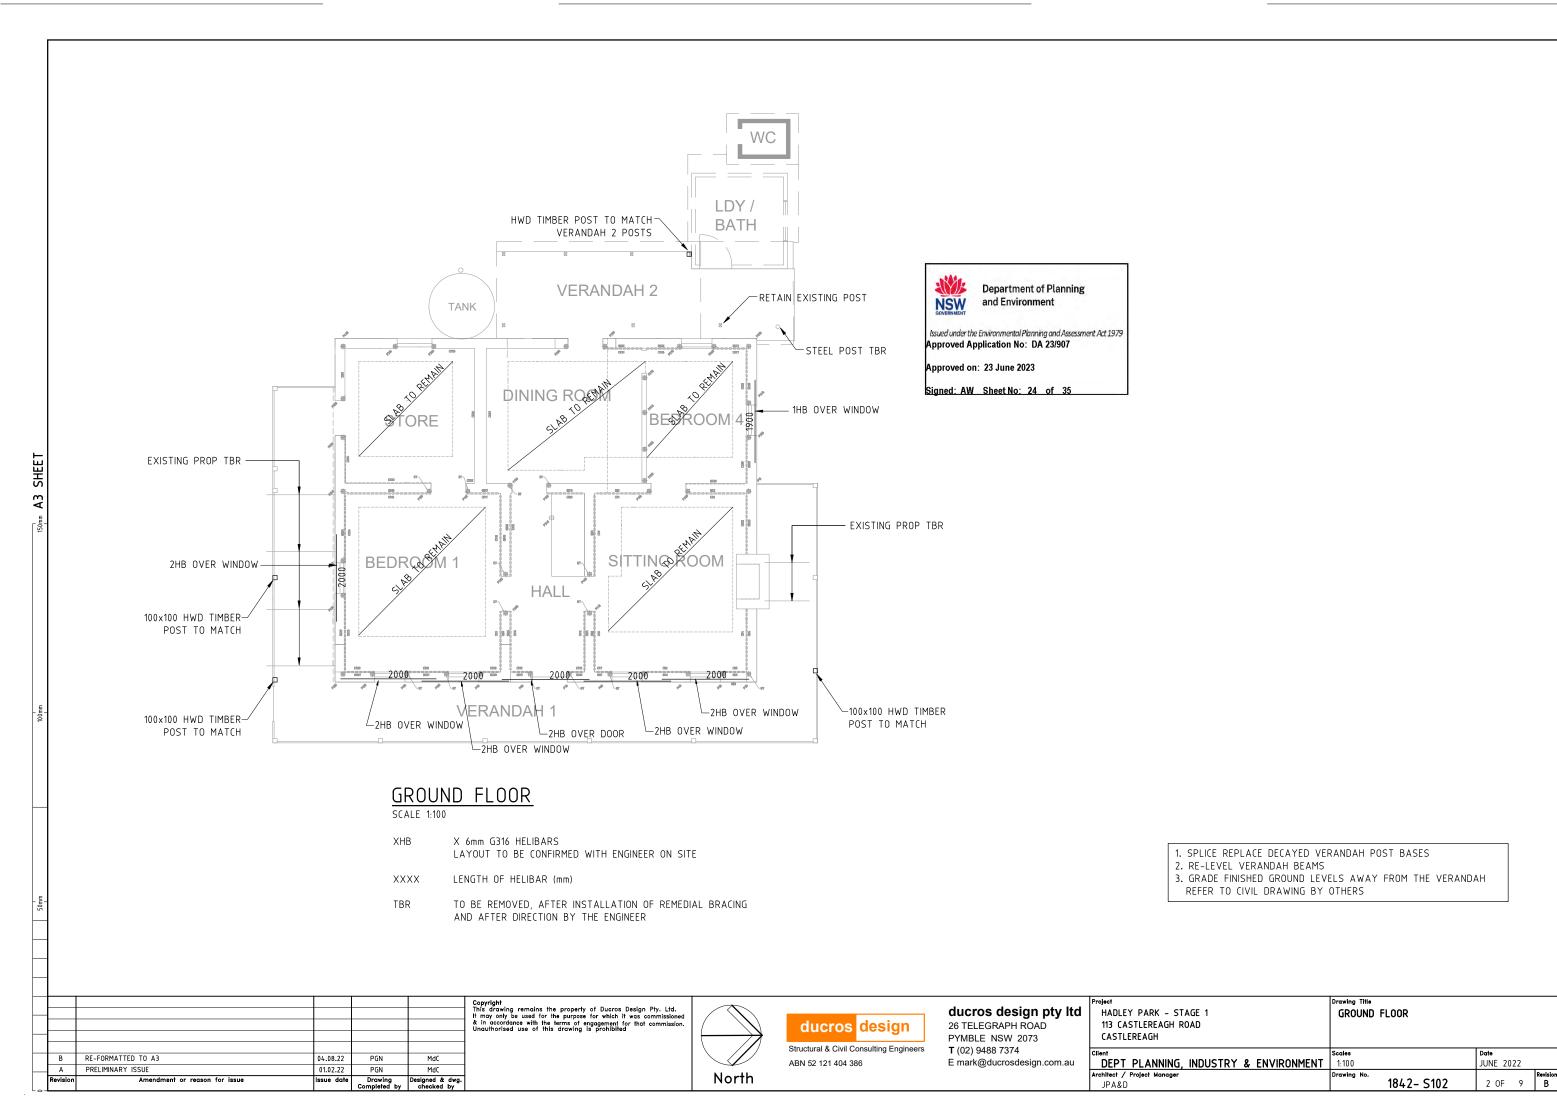

XXXX LENGTH OF HELIBAR (mm)

TBR TO BE REMOVED, AFTER INSTALLATION OF REMEDIAL BRACING

AND AFTER DIRECTION BY THE ENGINEER

	Revision	Amendment or reason for issue	Issue date	Drawing Completed by	Designed & dwg. checked by	
	Α	PRELIMINARY ISSUE	01.02.22	PGN	MdC	
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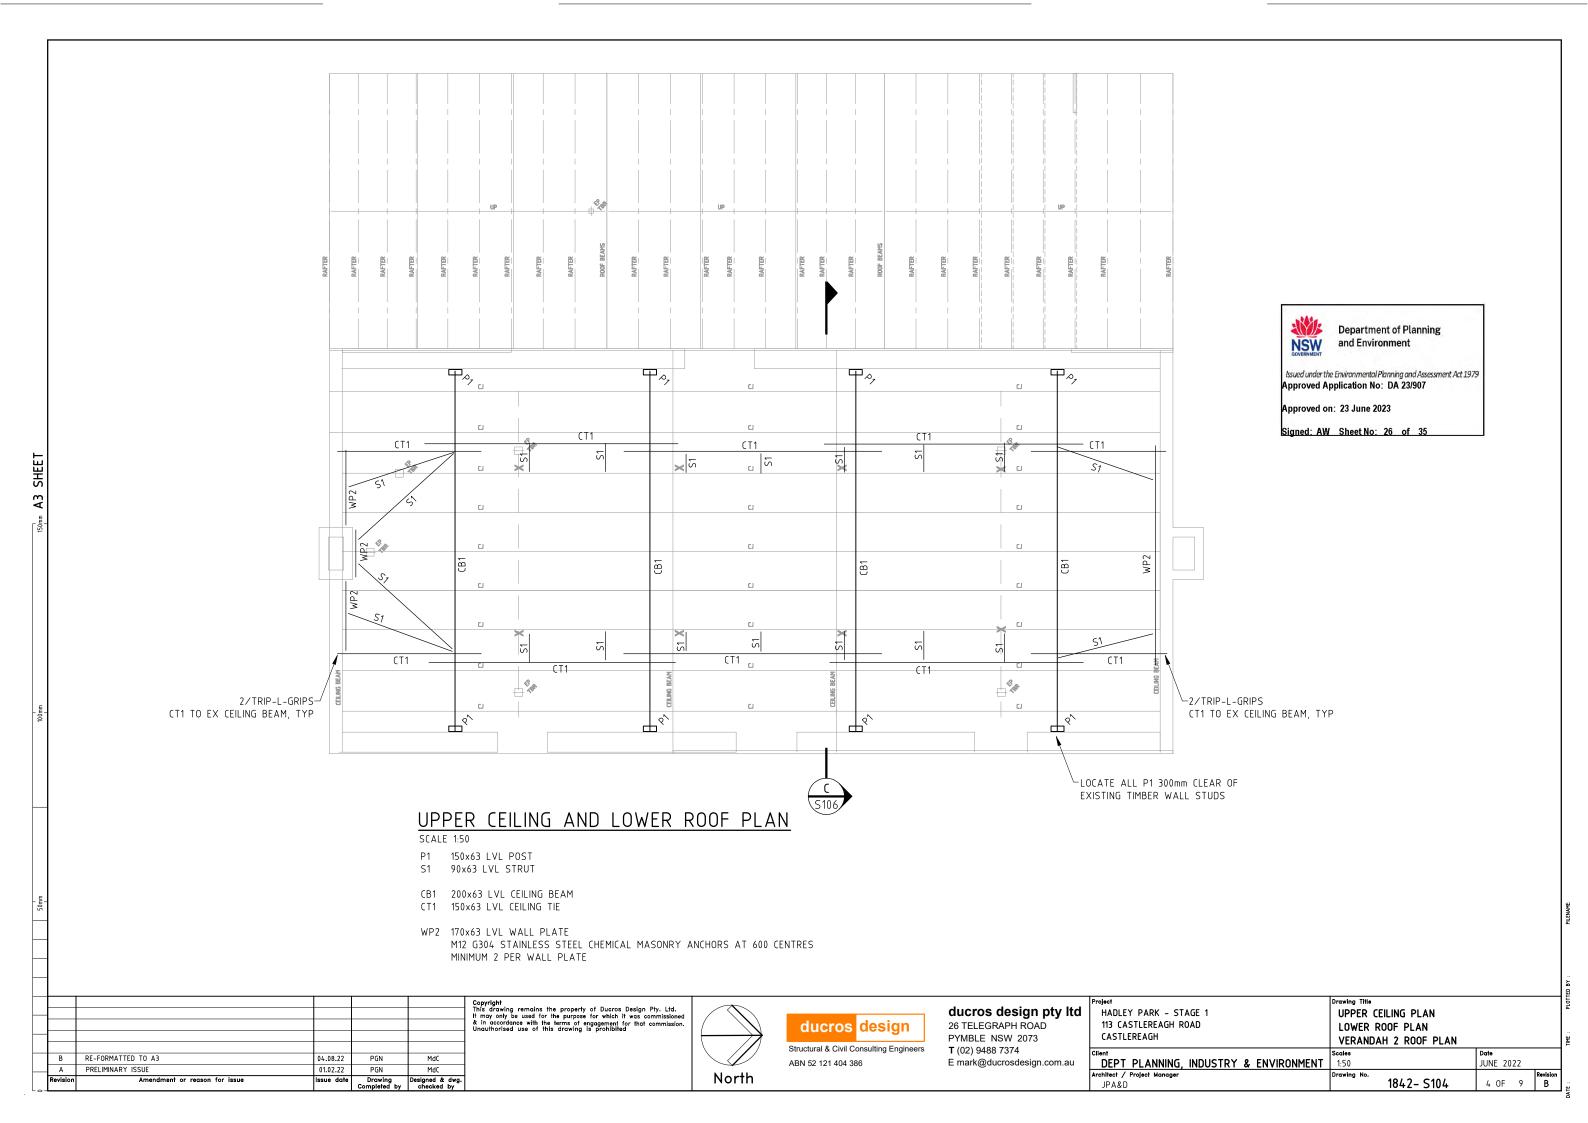
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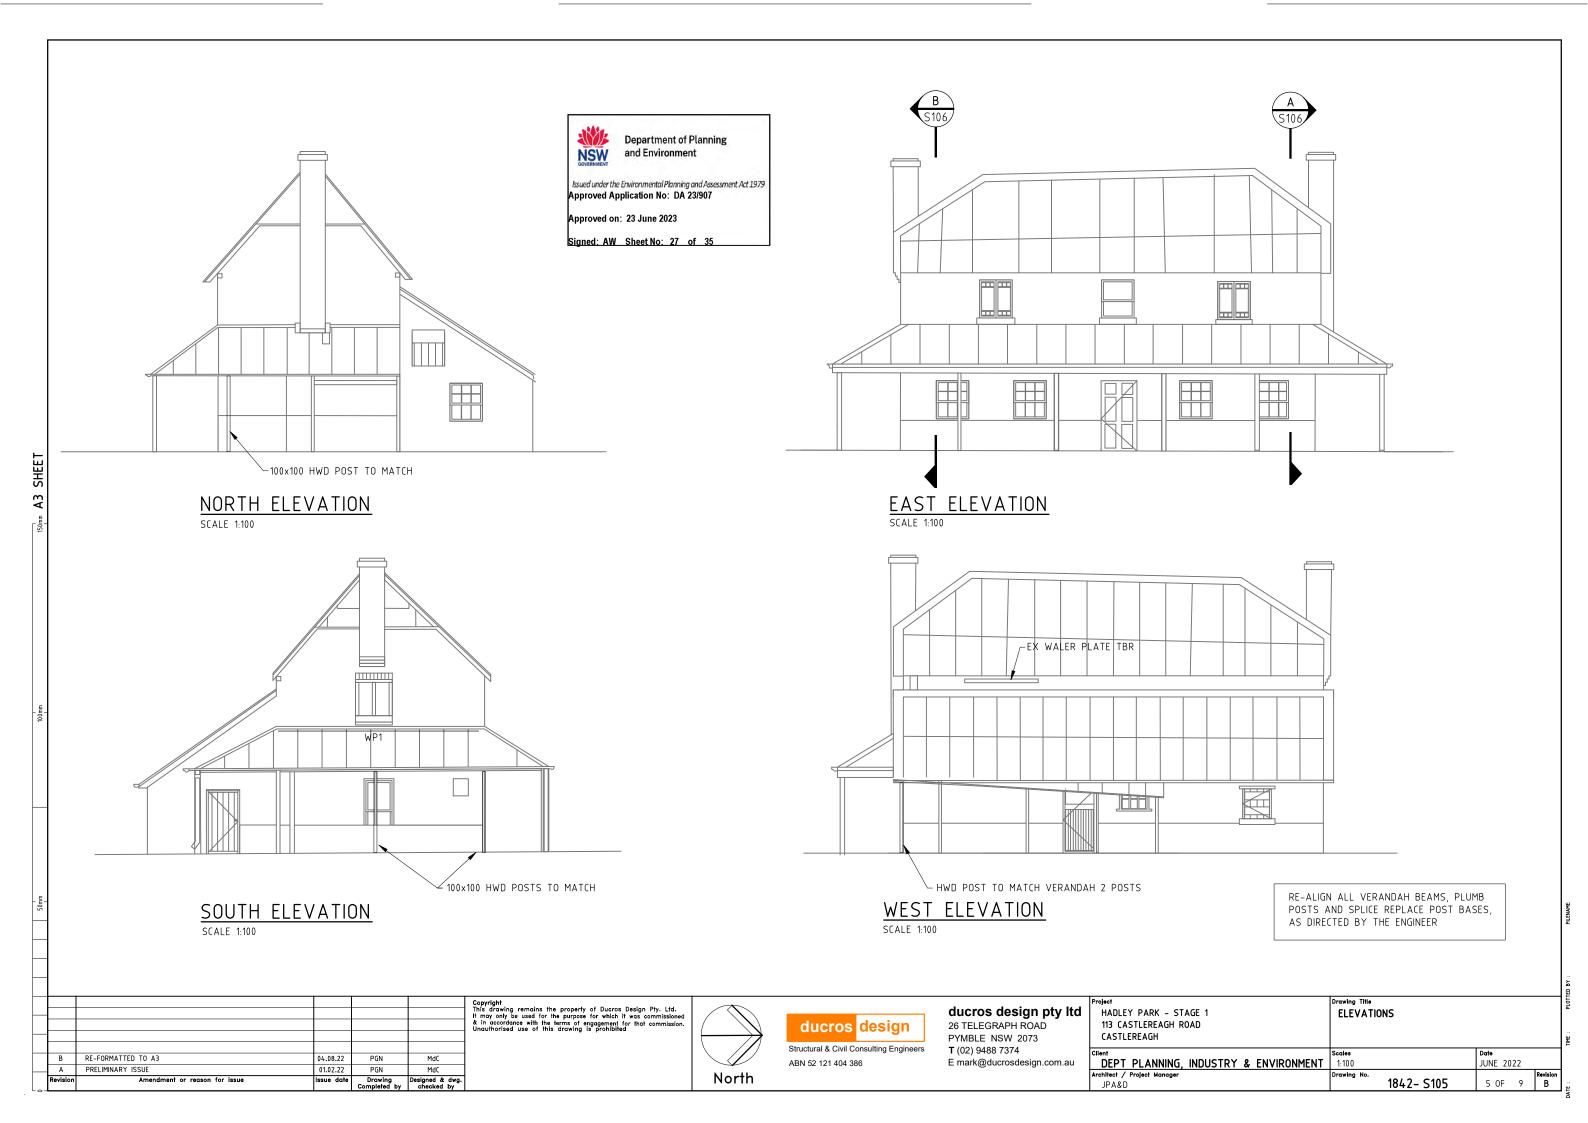
roject	Drawing Title
HADLEY PARK - STAGE 1	FIRST FLOOR PLAN
113 CASTLEREAGH ROAD	LOWER CEILING PLAN
CASTLEREAGH	VERANDAH 2 ROOF PLAN
lient	Scales
DEPT PLANNING, INDUSTRY & ENVIRONMENT	1:100


JUNE 2022


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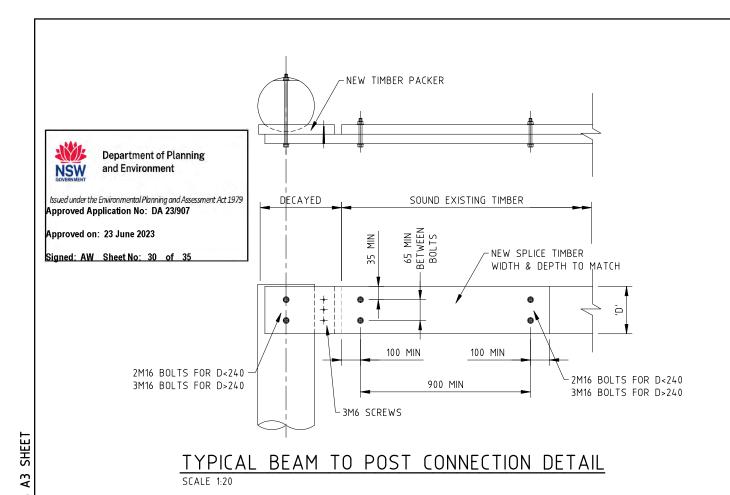
3 OF 9 B








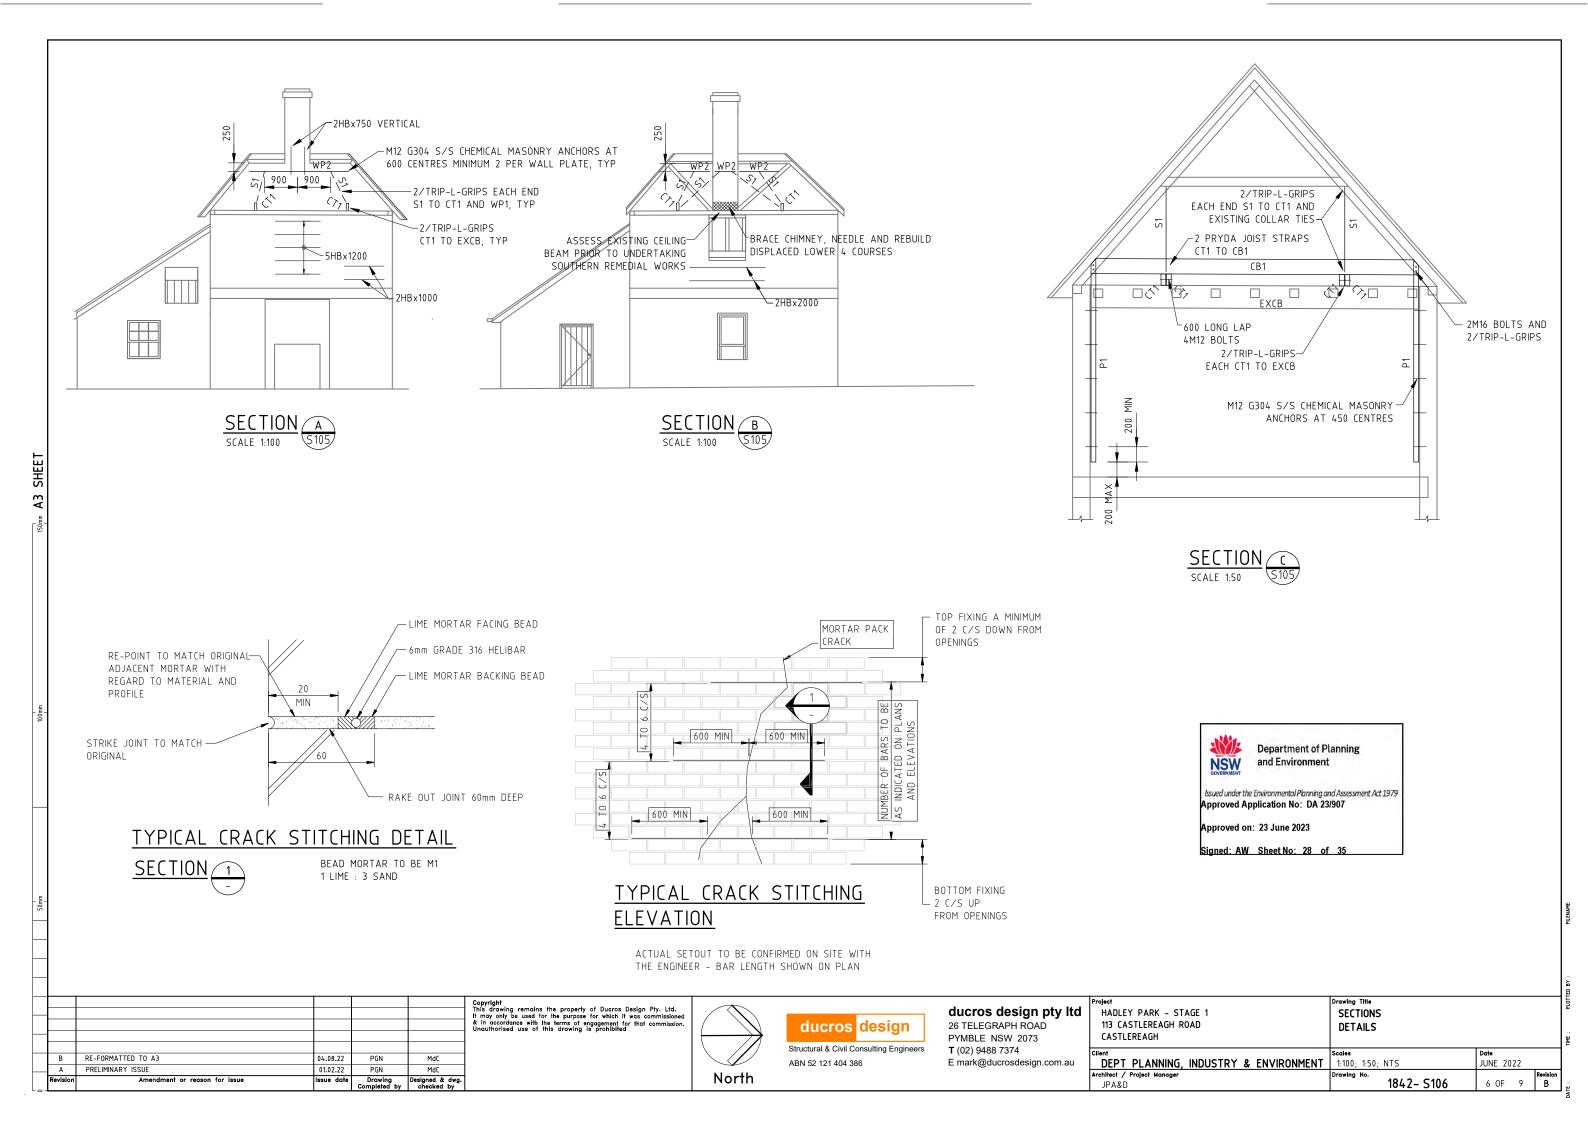

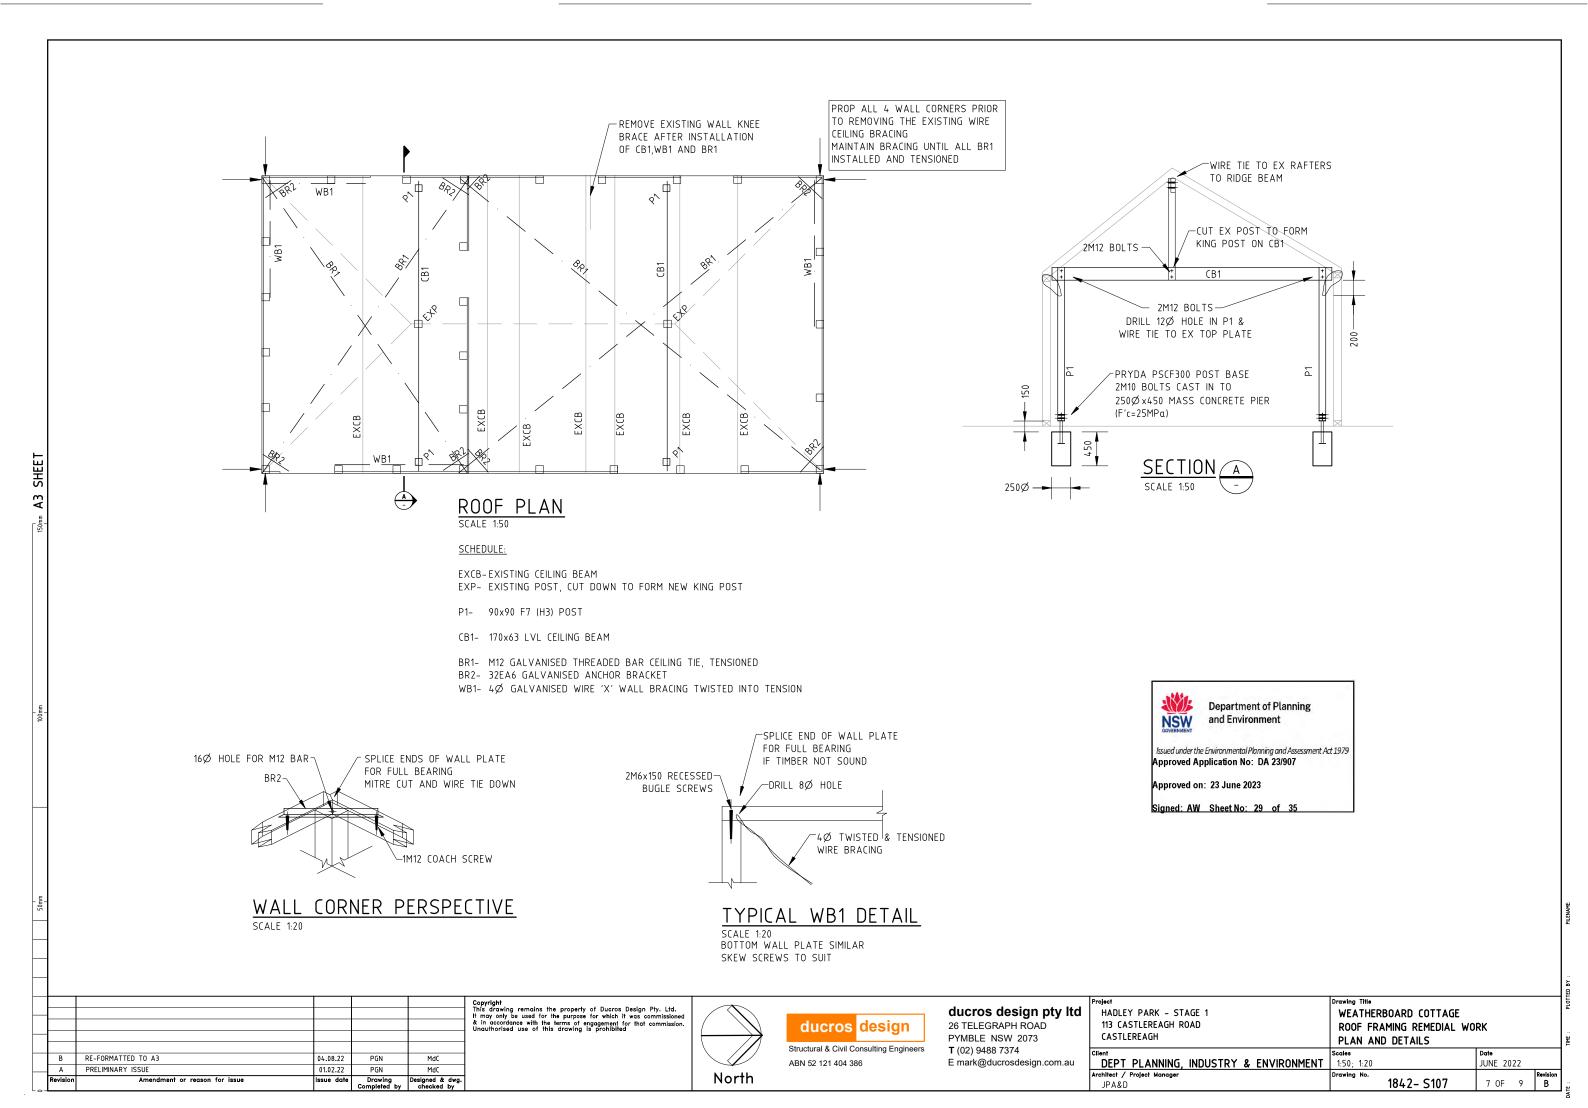


# NEW TIMBER SPLICE -NEW TIMBER SPLICE --2M12 BOLTS -2M16 BOLTS >250

# TYPICAL POST EXTENSION DETAILS

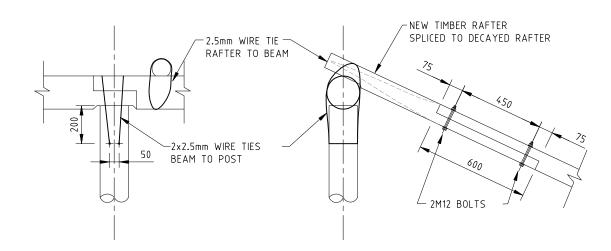

# TYPICAL RAFTER TO BEAM CONNECTION DETAIL

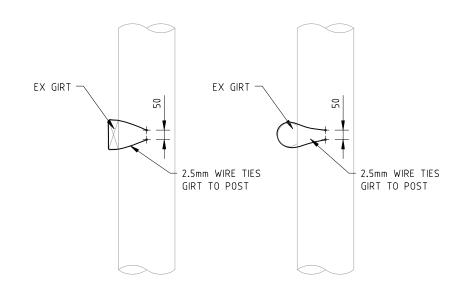

# TYPICAL GIRT TO POST DETAILS

# NOTES:

- 1. ALL WIRE TIES TO BE Ø 2.5mm Ø 2.5mm GALVANISED, TENSIONED AND TIED OFF
- 2. ALL SCREWS AND BOLTS TO BE GALVANISED
- 3. PSR DENOTES "POLESAVER ROD" OR APPROVED EQUIVALENT, INSTALLED IN ACCORDANCE WITH MANUFACTURER'S RECOMMENDATIONS
- 4. STABILISE DGB20 USING 4% GP CEMENT

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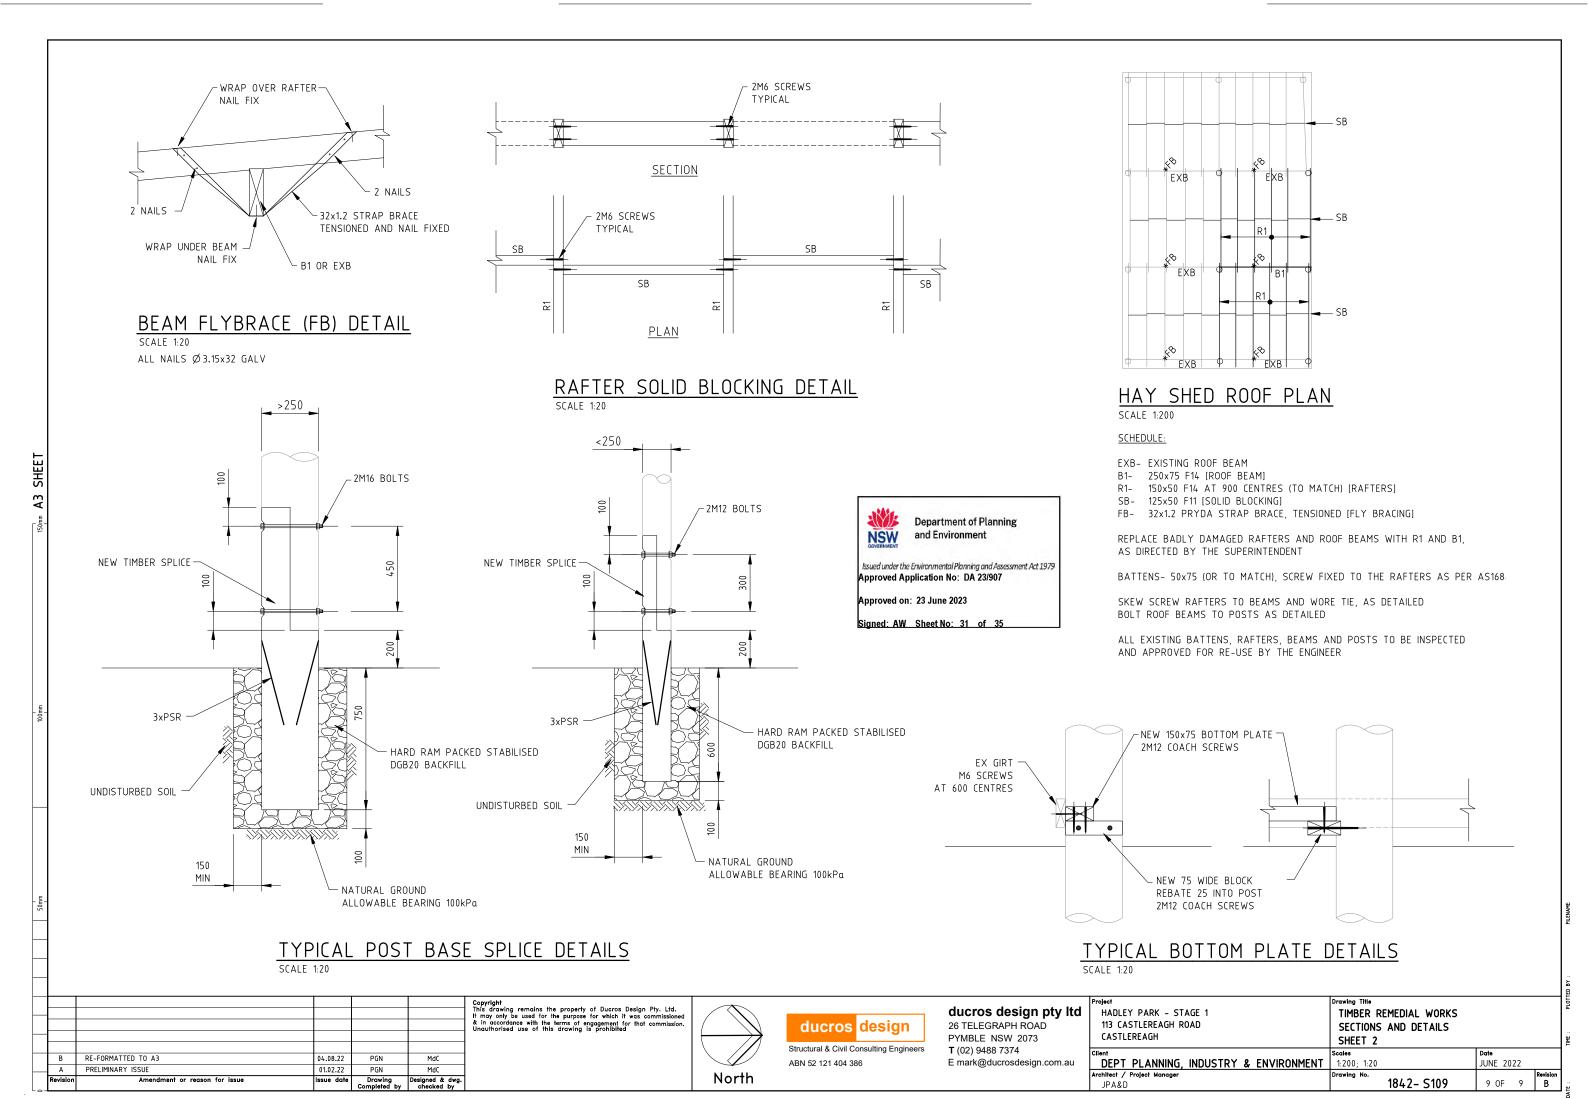
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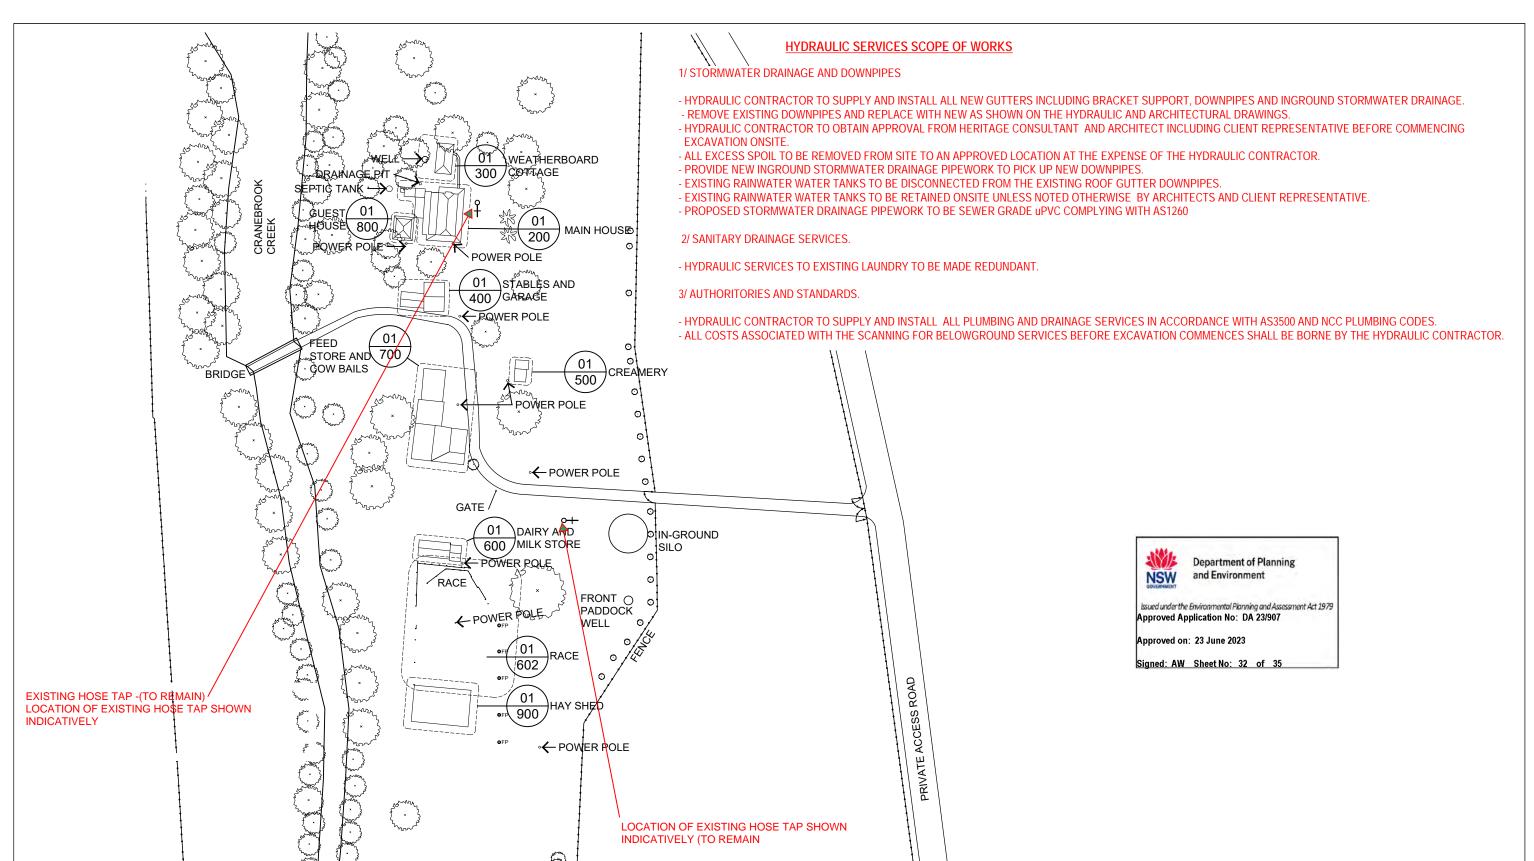
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Project	Drawing Title		
HADLEY PARK - STAGE 1	TIMBER REMEDIAL WORKS		
113 CASTLEREAGH ROAD	SECTIONS AND DETAILS		
CASTLEREAGH	SHEET 1		
Client	Scales	Date	
DEPT PLANNING, INDUSTRY & ENVIRONMENT	1:100; 1:20	JUNE 2022	
Architect / Project Manager JPA&D	Drawing No. 1842- S108	8 OF 9	Revision B








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	P2	15/12/2022	PRELIMINARY ISSUE - DA SUBMISSION	KA
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Client:



Architect:

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SYDNEY . GOLD COAST . MELBOURNE . WOLLONGONG . CANBER

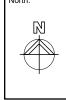STAGE 1 14-278 OLD CASTLEREAGH **ROAD CASTLEREAGH** 

HADLEY PARK

•	HYDRAULIC SERVICES
	Title

H-01 SITE PLAN HYDRALIC SERVICES Issue : P3

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